


TOWN OF SOUTHWEST RANCHES & SOUTH BROWARD DRAINAGE DISTRICT S.W. 50th STREET/S.W. 182nd TERRACE DRAINAGE IMPROVEMENTS

TOWN OF SOUTHWEST RANCHES
13400 GRIFFIN ROAD
SOUTHWEST RANCHES, FLORIDA 33330



SOUTH BROWARD DRAINAGE DISTRICT
6591 SW 160th AVE.
SOUTHWEST RANCHES, FLORIDA 33331

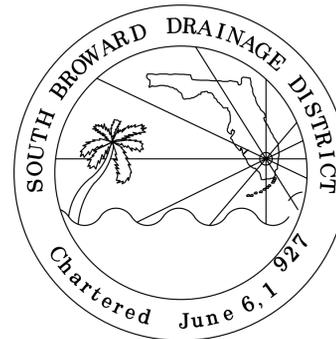


Know what's below.
Call before you dig.

TOWN OF SOUTHWEST RANCHES COUNCIL:

Doug McKay (Mayor)
Gary Jablonski (Vice Mayor)
Denise Schroeder (Council Member)
Freddy Fisikelli (Council Member)
Robert Hartman (Council Member)


DRAWING INDEX:

COVER SHEET	- 1
50th STREET PAVING & DRAINAGE PLAN	- 2
50th STREET PAVING & DRAINAGE PLAN	- 3
DETAILS	- 4
50th STREET EROSION CONTROL PLAN	- 5
50th STREET EROSION CONTROL PLAN	- 6
EROSION CONTROL DETAILS	- 7
SURVEY (SHEET 1 OF 2)	- 8
SURVEY (SHEET 2 OF 2)	- 8

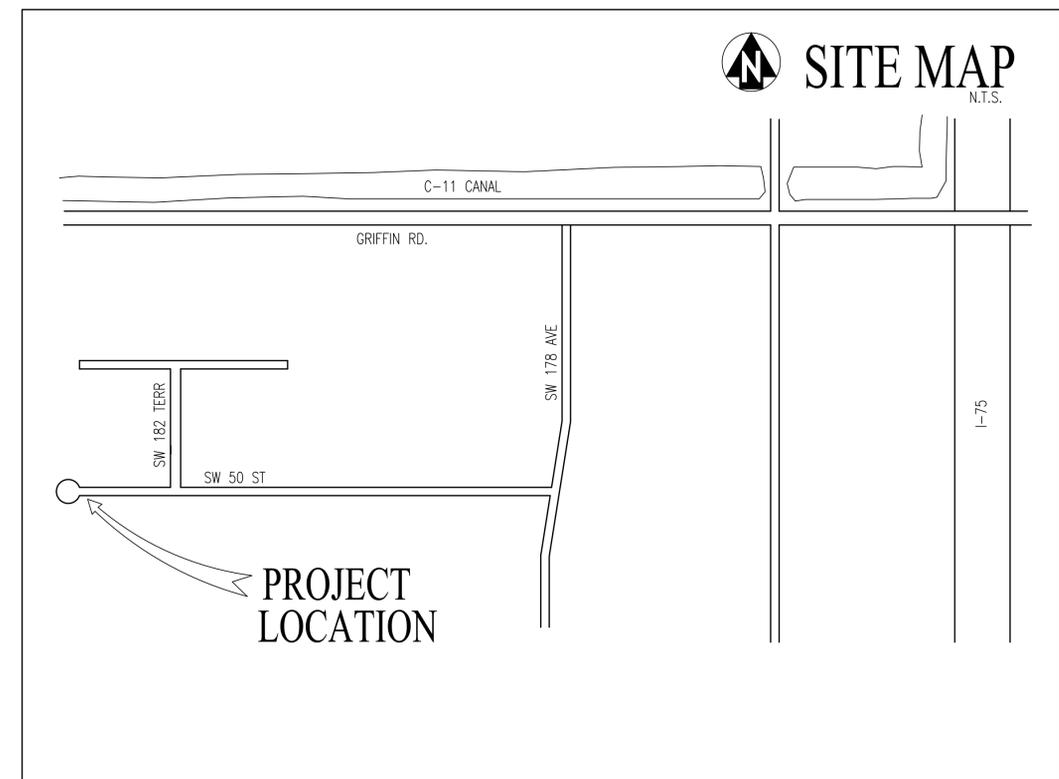


Notes

1. All elevations shown on this plan are based on the North American Vertical Datum of 1988 (NAVD 88) is: NAVD 88 = NGVD 29 - 1.51'
2. Contractor shall verify the location, size, material, and depth of all existing underground utility lines prior to beginning the work.
3. Contractor shall exercise extreme caution when working under and around existing overhead or underground electric lines. Contractor shall notify and coordinate with FPL on any safety or other issues regarding overhead or underground power lines.
4. Contractor shall submit a Maintenance of Traffic (MOT) Plan to the Town of SW Ranches for approval for any impacts to the flow of traffic on local Town roads.
5. Any required density tests or materials testing shall be paid for by the contractor.
6. The limits of the Project areas shall be restored in a manner that meets or exceeds the conditions of the Project areas prior to the start of construction. Sod shall match the type of sod of the surrounding areas unless Bahia is requested by the Town. Contractor shall be responsible for watering of the sod until final acceptance of the work.
7. Contractor shall be responsible to completely restore the limits of construction including, but not limited to, sod, pavement, driveways, catch basin aprons, fencing, landscaping and irrigation.
8. Contractor shall be responsible to obtain a dewatering permit for the any dewatering activities (at the sole cost to the Contractor).
9. Contractor shall comply with all requirements of Section 403.0885, Florida Statutes for NPDES, including, but not limited to, filing a Notice of Intent as applicable.
10. Contractor shall install Mirafit filter fabric under inlet grates to protect against sedimentation.
11. Contractor shall notify and coordinate with the Town of SW Ranches for all work within the Town limits.

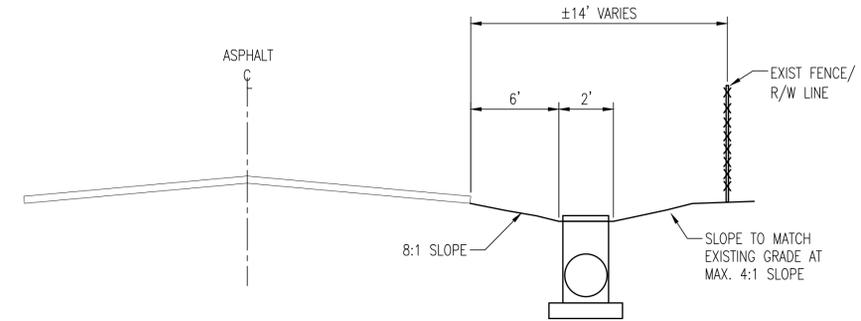

SECTION A-A (TYPICAL SWALE SECTION)

NO SCALE

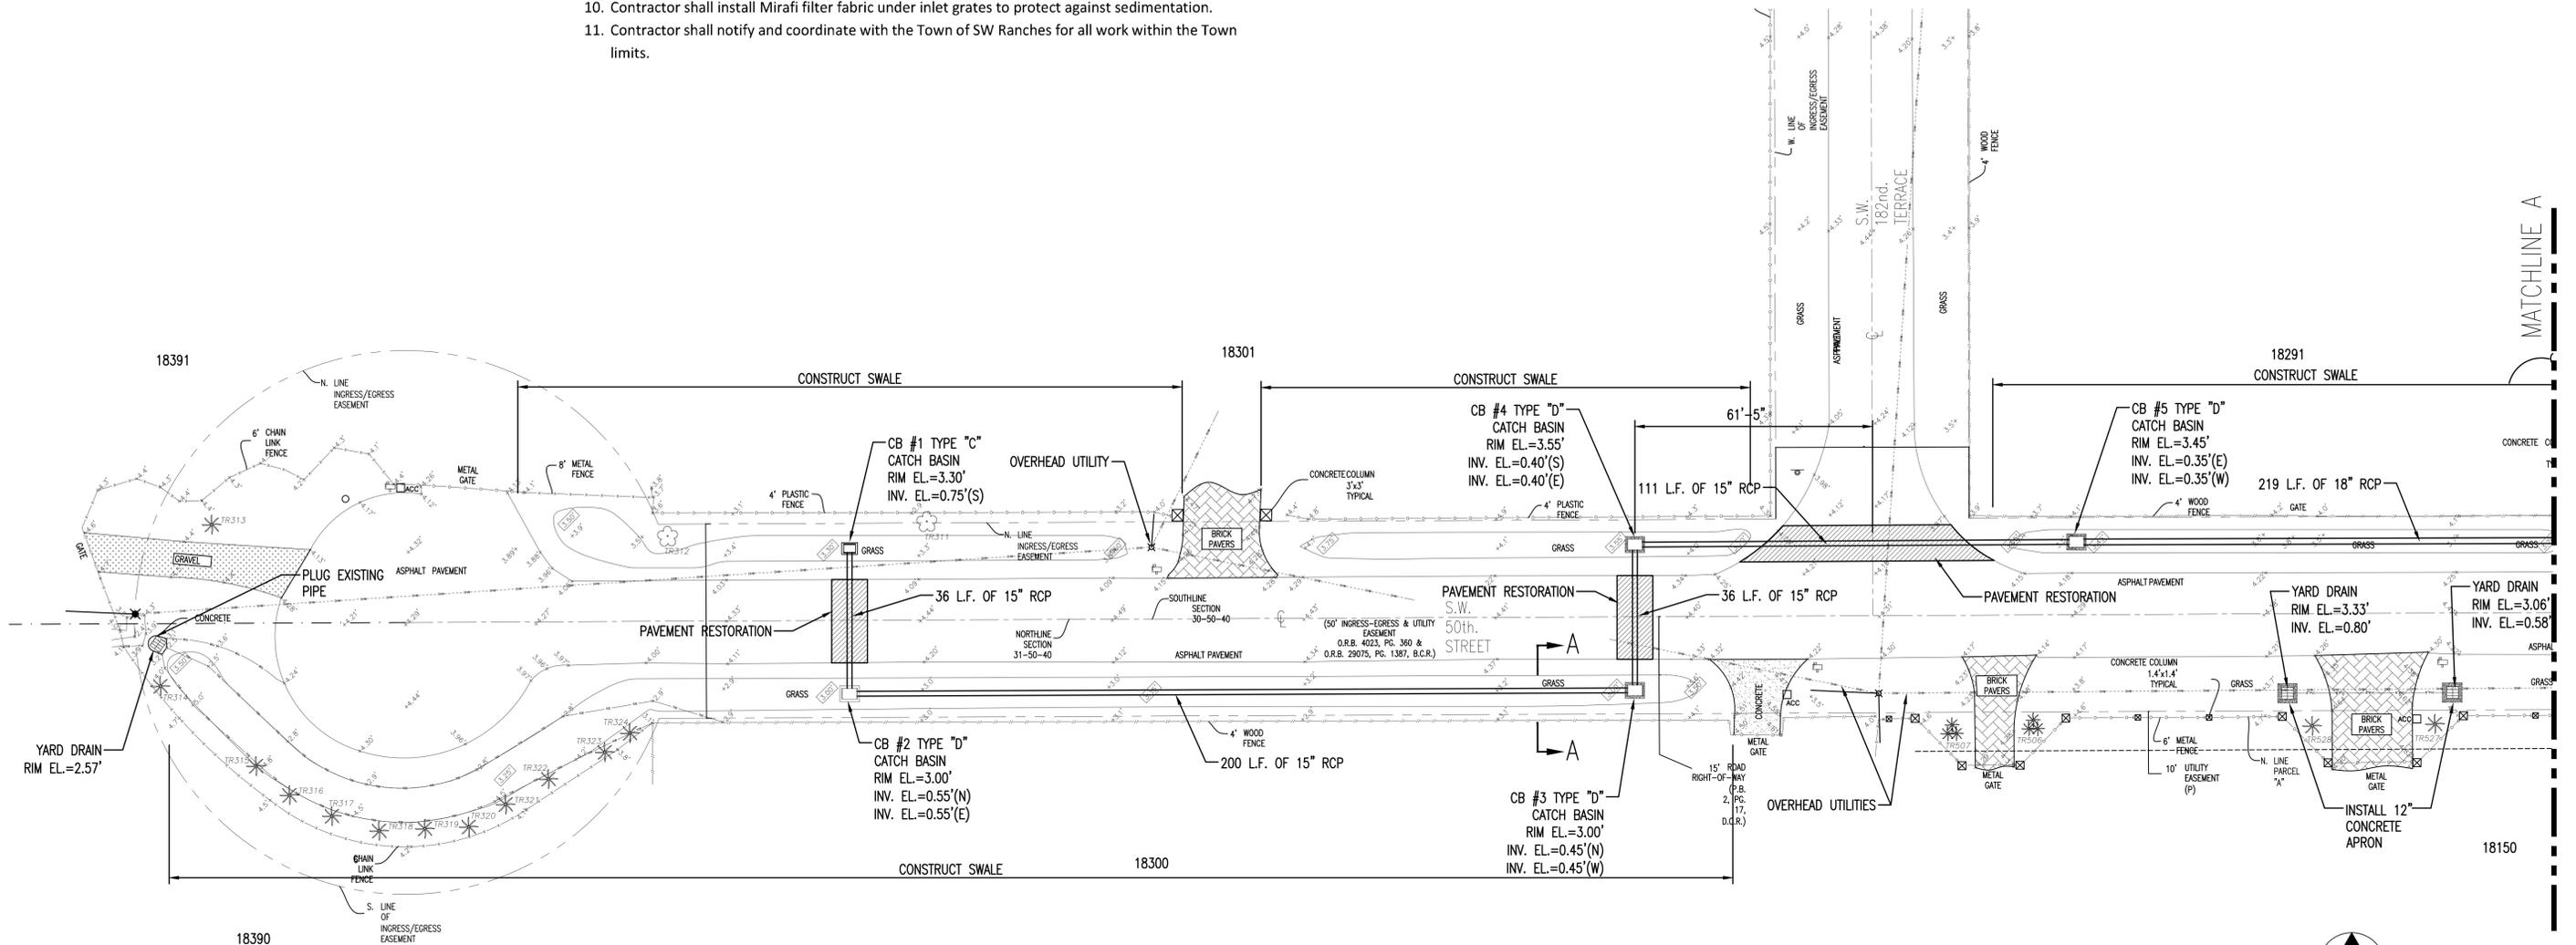

PAVING AND DRAINAGE PLAN

NOTE:
PRIOR TO STARTING CONSTRUCTION, CONTRACTOR SHALL LOCATE AND UNCOVER EXISTING UNDERGROUND CABLE AND POWER LINES TO VERIFY LOCATIONS AND COORDINATE ANY CONFLICTS WITH THE SBDD.




SCALE: 1"=20'-0"

NO	DATE	REVISION	BY	NO	DATE	REVISION	BY
1							

SOUTH BROWARD DRAINAGE DISTRICT
SW 50th STREET
SOUTHWEST RANCHES, FL. 33331


PAVING AND DRAINAGE PLAN
S.W. 50th STREET/S.W.182nd TERRACE IMPROVEMENT PROJECT
SOUTHWEST RANCHES, FLORIDA

DRAWN BY:
J.K.S.
APPROVED BY:
K.M.H.
DATE 5-24-19

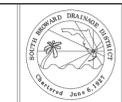

SCALE AS NOTED
PROJECT No
CAD FILE


SHEET
1 OF 8

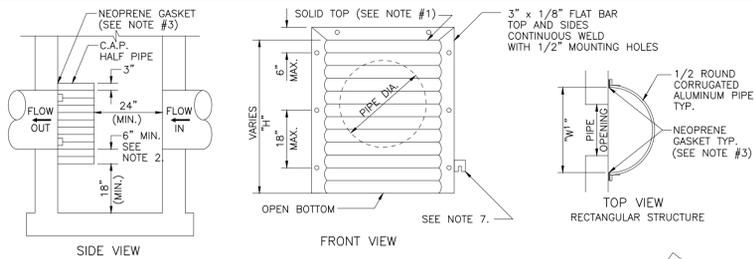



PIPE DIA.	W (IN)	W ² (IN)	T (GAUGE)	H (IN)
15"	21"	21"	16	VARIES
18"	24"	24"	16	VARIES
21"	30"	30"	16	VARIES
24"	30"	36"	16	VARIES
30"	36"	42"	14	VARIES
36"	42"	48"	14	VARIES
42"	48"	54"	14	VARIES
48"	54"	60"	14	VARIES
54"	60"	66"	14	VARIES

- NOTES:**
- ALUMINUM SHEET OF SAME THICKNESS (GAUGE) AS PIPE SHALL BE WELDED TO CLOSE OPENING AT THE TOP.
 - THE BOTTOM ELEVATION OF THE POLLUTION RETARDANT BAFFLE MUST BE AT LEAST 2" BELOW CONTROL ELEVATION.
 - NEOPRENE ADHESIVE BACKED GASKET, OR APPROVED EQUAL (1" x 2") SHALL BE INSTALLED ON THE SIDES AND TOP OF ALL BAFFLES.
 - POLLUTION RETARDANT BAFFLE TO BE FASTENED IN PLACE WITH 3/8"x4" STAINLESS STEEL "RED HEADS", OR APPROVED EQUAL.
 - ALL EXFILTRATION TRENCHES SHALL HAVE A POLLUTION RETARDANT BAFFLE AT EACH CONNECTION POINT TO A STRUCTURE (SEE EXFILTRATION TRENCH DETAIL).
 - FIBERGLASS BAFFLES ARE NOT PERMITTED.
 - MOUNTING BRACKETS MAY BE ADDED TO FLAT BARS TO EASE INSTALLATION IN ROUND STRUCTURES. SPACING TO MATCH HOLES IN FLAT BARS.


POLLUTION RETARDANT BAFFLE DETAIL

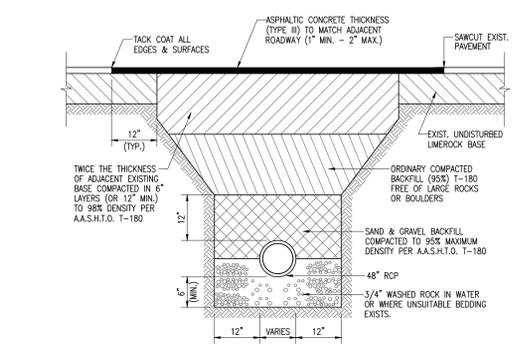


PAVEMENT RESTORATION DETAIL

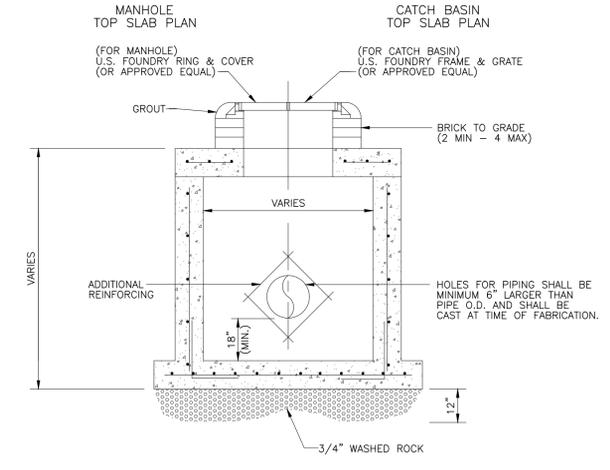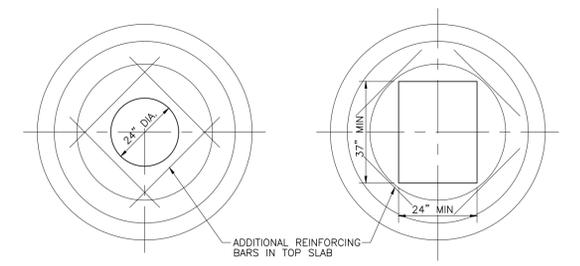

PRECAST CATCH BASIN AND MANHOLE DETAIL

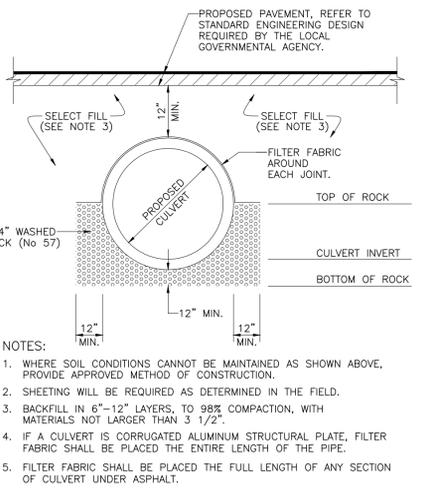


LAKE/CANAL INTERCONNECT BEDDING DETAIL

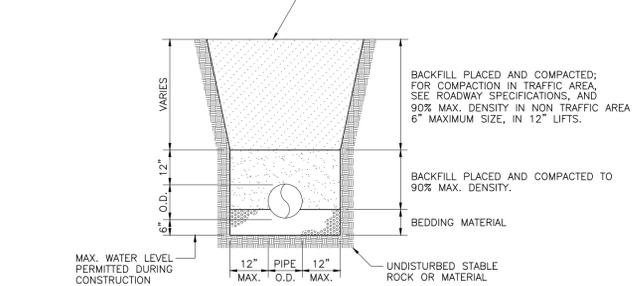

- NOTES:**
- WHERE SOIL CONDITION CANNOT BE MAINTAINED AS SHOWN ABOVE, PROVIDE APPROVED MEANS OF CONSTRUCTION.
 - WHERE REQUIRED, SHEETING AND SHORING SHALL BE IN ACCORDANCE WITH THE LOCAL GOVERNMENTAL AGENCY.
 - MUCK OR OTHER UNSUITABLE MATERIAL SHALL BE COMPLETELY REMOVED.
 - WHEN THE PIPE IS LAID IN THE PREPARED TRENCH, TRUE TO LINE AND GRADE, THE PIPE BARREL SHALL RECEIVE CONTINUOUS UNIFORM SUPPORT. WHERE NECESSARY, COURSE SAND, PEA ROCK OR 3/4" LIMESTONE GRAVEL SHALL BE USED TO PROVIDE UNIFORM BEDDING.
 - JOINTS MAY BE REQUIRED TO BE WRAPPED AT THE DISCRETION OF THE DISTRICT AND THE SITE CONDITIONS.
 - BACKFILL MATERIAL SHALL BE NON-COHESIVE AND NON-PLASTIC SOIL THAT IS FREE OF ALL DEBRIS, LUMPS, WOOD BROKEN PAVING OR ANY ORGANIC OR UNSUITABLE MATERIAL. BACKFILL MATERIAL PLACED WITHIN 12" OF THE PIPE SHALL CONTAIN NO ROCKS OR STONES LARGER THAN 3-1/2" INCHES IN DIAMETER. NO ROCKS OR STONES LARGER THAN 6" IN DIAMETER WILL BE PERMITTED IN THE REMAINING BACKFILL UNLESS OTHERWISE SPECIFIED.
 - TRENCH BACKFILL SHALL BE COMPACTED TO NOT LESS THAN 90 PERCENT OF THE MAXIMUM DRY DENSITY DETERMINED BY AASHTO T-180. BACKFILL AND COMPACTION SHALL BE IN ACCORDANCE TO THE STANDARD ENGINEERING DESIGN REQUIRED BY THE LOCAL GOVERNMENTAL AGENCY.

TRENCH EXCAVATION DETAIL

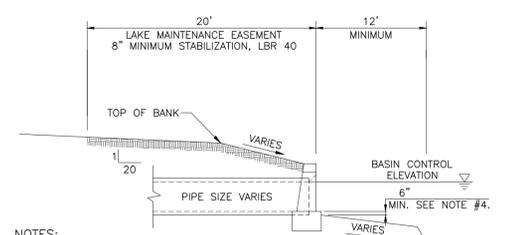

- NOTES:**
- TOP OF CAP TO BE 1" ABOVE THE BASIN CONTROL ELEVATION FOR LAKES AND 2' ABOVE BASIN CONTROL ELEVATION FOR CANALS, UNLESS OTHERWISE APPROVED BY THE DISTRICT.
 - REQUIRED FOR ALL LAKE AND CANAL INTERCONNECTS.
 - CONCRETE AND RIP-RAP ENDWALLS ARE ACCEPTED PER FDOT INDEX 250-255 AND INDEX 258 WITH EXCEPTIONS AS NOTED IN SECTION 2.15 OF THE SBDD DESIGN CRITERIA MANUAL.
 - CHANNEL IN FRONT OF PIPE TO BE MIN 6" BELOW THE INVERT OF THE PIPE AND AT LEAST 1 1/2 TIMES THE DIA. OF THE PIPE TO THE DEEP CUT LINE AND CENTERED ON THE PIPE.

LAKE OUTFALL DETAIL WITH HEADWALL


- GENERAL NOTES**
- THE FOLLOWING GENERAL NOTES ARE REQUIRED BY THE SOUTH BROWARD DRAINAGE DISTRICT (SBDD). THEY ARE NOT MEANT TO BE ALL INCLUSIVE. IT IS THE ENGINEER'S RESPONSIBILITY TO ADD ANY NOTES WHICH WILL INFORM THE OWNER AND THE CONTRACTOR OF ANY ADDITIONAL REQUIREMENTS OF SBDD.
 - THE CONTRACTOR SHALL CONTACT SBDD 48 HOURS OR TWO (2) WORKING DAYS PRIOR TO ANY REQUIRED INSPECTION. TO SCHEDULE INSPECTIONS, PLEASE CALL SBDD AT (954)680-3337. SBDD'S WORKING HOURS ARE FROM 8:00 AM TO 4:30 PM, MONDAY THROUGH FRIDAY EXCEPT HOLIDAYS.
 - ANY REVISIONS TO PLANS PERMITTED BY SBDD MUST BE APPROVED BY SBDD PRIOR TO CONSTRUCTION.
 - A PRECONSTRUCTION MEETING SHALL BE SCHEDULED AND HELD AT LEAST FIVE (5) DAYS PRIOR TO BEGINNING CONSTRUCTION.
 - A SET OF SHOP DRAWINGS SHALL BE SUBMITTED TO SBDD AFTER APPROVAL BY THE ENGINEER OF RECORD.
 - DURING CONSTRUCTION, SBDD PERSONNEL WILL INSPECT THE FOLLOWING:
.. INSTALLATION OF ALL UNDERGROUND DRAINAGE FACILITIES BEFORE BACKFILLING,
.. BACKFILLING OF DRAINAGE TRENCHES,
.. SHAPING OF CANAL AND LAKE BANKS FROM THE DEEP CUT TO THE UPLAND EASEMENT LINE OR AS REQUIRED BY SBDD,
AND ANY OTHER DRAINAGE RELATED CONSTRUCTION WORK.
RE-INSPECTIONS OR EXTRAORDINARY INSPECTIONS WILL BE SUBJECT TO ADDITIONAL FEE CHARGES BY SBDD.
 - THE CONTRACTOR CONSTRUCTING OR EXCAVATING LAKES OR OTHER WATER BODIES SHALL EXERCISE EXTREME CAUTION TO ENSURE THAT THE SIDE SLOPES AND DEEP CUT LINES ARE CONSTRUCTED IN ACCORDANCE WITH THE APPROVED PLANS FOR THE DEVELOPMENT. THE CONTRACTOR OR OWNER SHALL PERIODICALLY, OR AS REQUIRED BY SBDD, OBTAIN A SURVEY, FROM A FLORIDA REGISTERED SURVEYOR OF THE LOCATION OF THE DEEP CUT LINES PRIOR TO FORMING THE SIDE SLOPES. THIS SURVEY SHALL BE PERFORMED PRIOR TO THE OWNER/CONTRACTOR BEGINNING CONSTRUCTION OF ANY BUILDING PADS ADJACENT TO THE WATER BODY. IN THE EVENT THAT THE CONTRACTOR OVER DIGS THE WATER BODY, THE OWNER/CONTRACTOR SHALL SUBMIT TO SBDD ITS SOLUTION TO CORRECT THE OVER DIGGING. ANY SUGGESTED REMEDY OR CORRECTION MUST BE APPROVED BY SBDD BEFORE THE CONTRACTOR BEGINS THE PROPOSED CORRECTION/REMEDY.
 - PAVING AND DRAINAGE "AS-BUILT" PLANS CERTIFIED BY THE ENGINEER OF RECORD AND APPROVED BY SBDD'S ENGINEER AND DIRECTOR WILL BE REQUIRED BEFORE THE RELEASE OF THE BOND OR LETTER OF CREDIT. AS-BUILTS SHALL BE PROVIDED AS AN OVERLAY OF THE APPROVED CONSTRUCTION DRAWINGS AND AT THE SAME SCALE AS ORIGINALLY SUBMITTED. AS-BUILT SUBMITTALS SHALL CONFORM TO THE REQUIREMENTS OF SECTION SIX (6) OF SBDD'S CRITERIA MANUAL. AS-BUILTS MUST ALSO BE PROVIDED ON AN AUTOCAD DISC.
 - AS-BUILT DRAWINGS OF WATER BODIES SHALL INCLUDE THE DATA ADDRESSED IN THE "AS-BUILT LAKE SECTION" IN EXHIBIT 26 OF SBDD'S CRITERIA MANUAL. THE AS-BUILT CROSS SECTIONS SHALL BE PROVIDED AT NOT MORE THAN 100 FOOT INTERVALS AND AT ALL OUTFALL PIPES CONSTRUCTED WITHOUT HEADWALLS.
 - SBDD WILL NOT COMPLETE THE FINAL INSPECTION UNTIL THE AS-BUILT PACKAGE WHICH WILL INCLUDE THE ENGINEER'S CERTIFICATION AND TEST RESULTS FOR STABILIZATION OF LAKE/CANAL MAINTENANCE EASEMENTS, ARE RECEIVED.

NO	DATE	REVISION	BY	NO	DATE	REVISION	BY
1							

SOUTH BROWARD DRAINAGE DISTRICT
6591 SW 160th AVE
SOUTHWEST RANCHES, FL. 33331

PAVING & DRAINAGE DETAILS
S.W. 50th STREET/S.W. 182nd TERRACE IMPROVEMENT PROJECT
SOUTHWEST RANCHES, FL.

DRAWN BY: J.K.S.		SCALE AS NOTED	SHEET 3 OF 8
APPROVED BY: K.M.H.		PROJECT No	
DATE 5-24-19		CAD FILE	

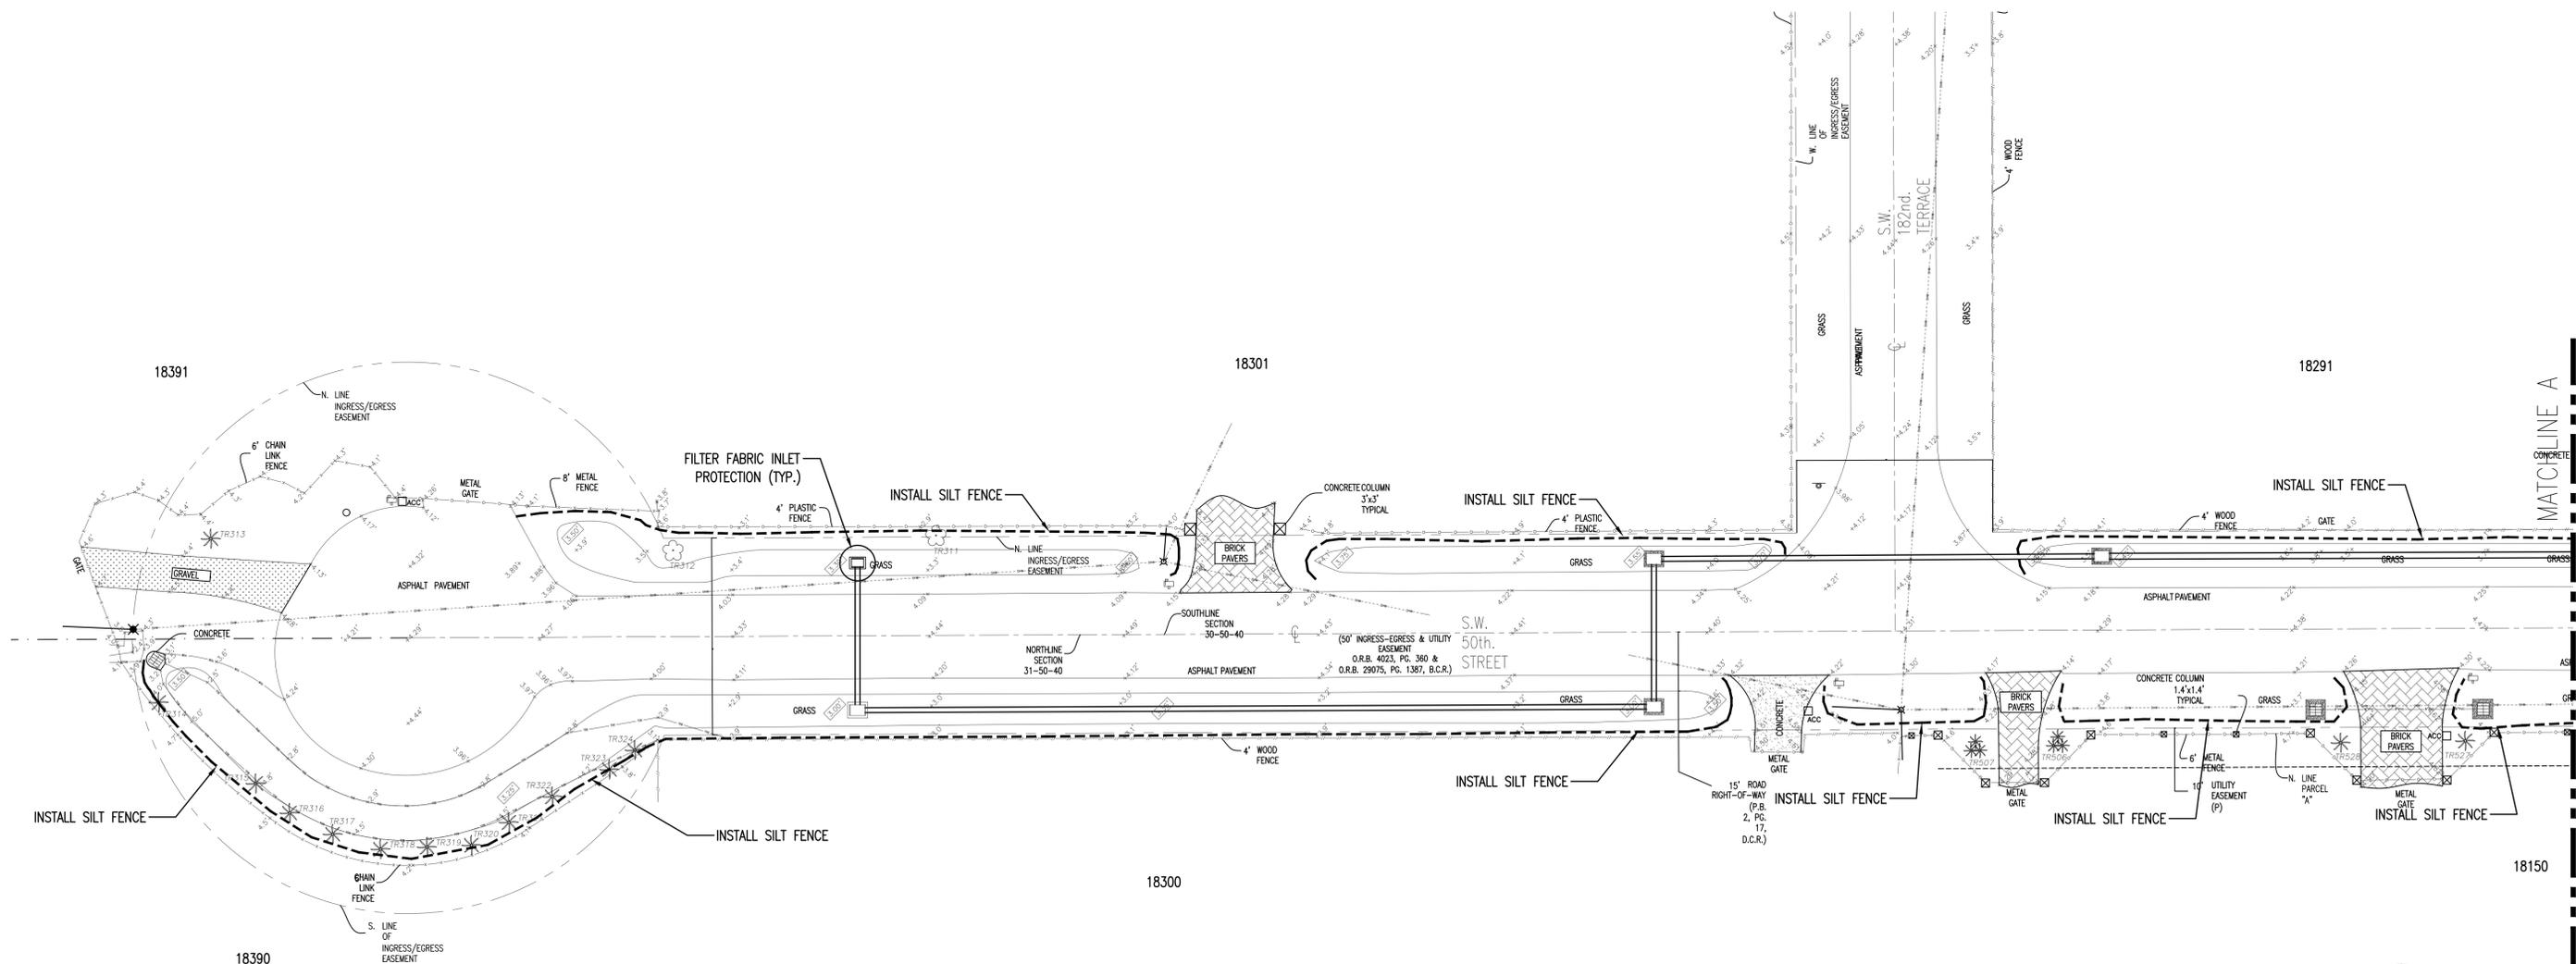

EROSION CONTROL PLAN




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SOUTH BROWARD DRAINAGE DISTRICT
 6591 SW 160th AVE
 SOUTHWEST RANCHES, FL. 33331



EROSION CONTROL PLAN
S.W. 50th STREET/S.W. 182nd TERRACE IMPROVEMENT PROJECT
 SOUTHWEST RANCHES, FLORIDA

DRAWN BY:
 J.K.S.
 APPROVED BY:
 K.M.H.
 DATE 5-24-19



SCALE AS NOTED
 PROJECT No
 CAD FILE

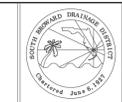SHEET
 4 OF 8

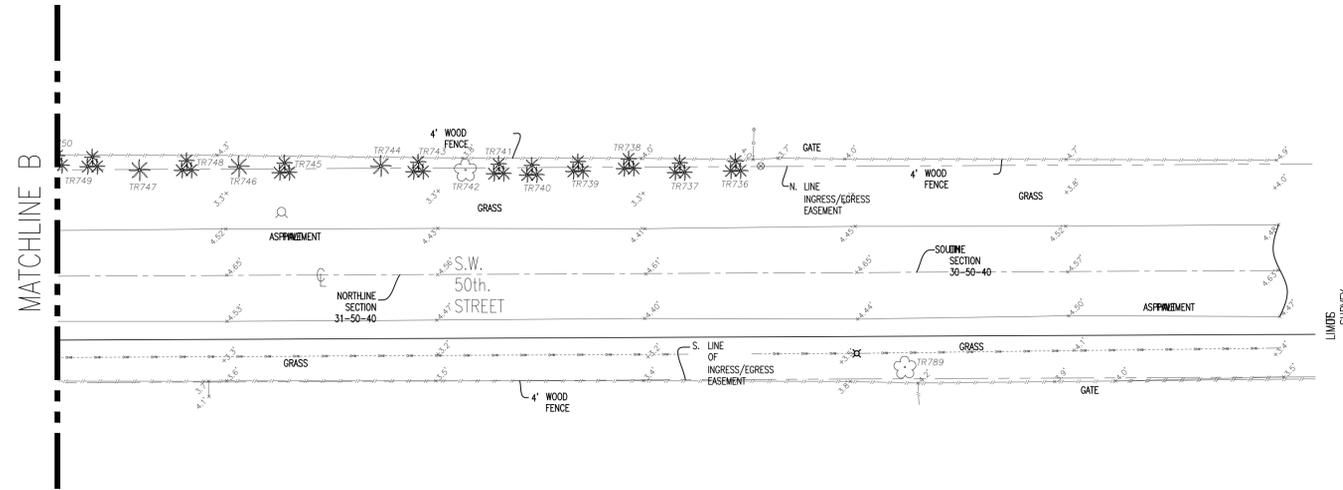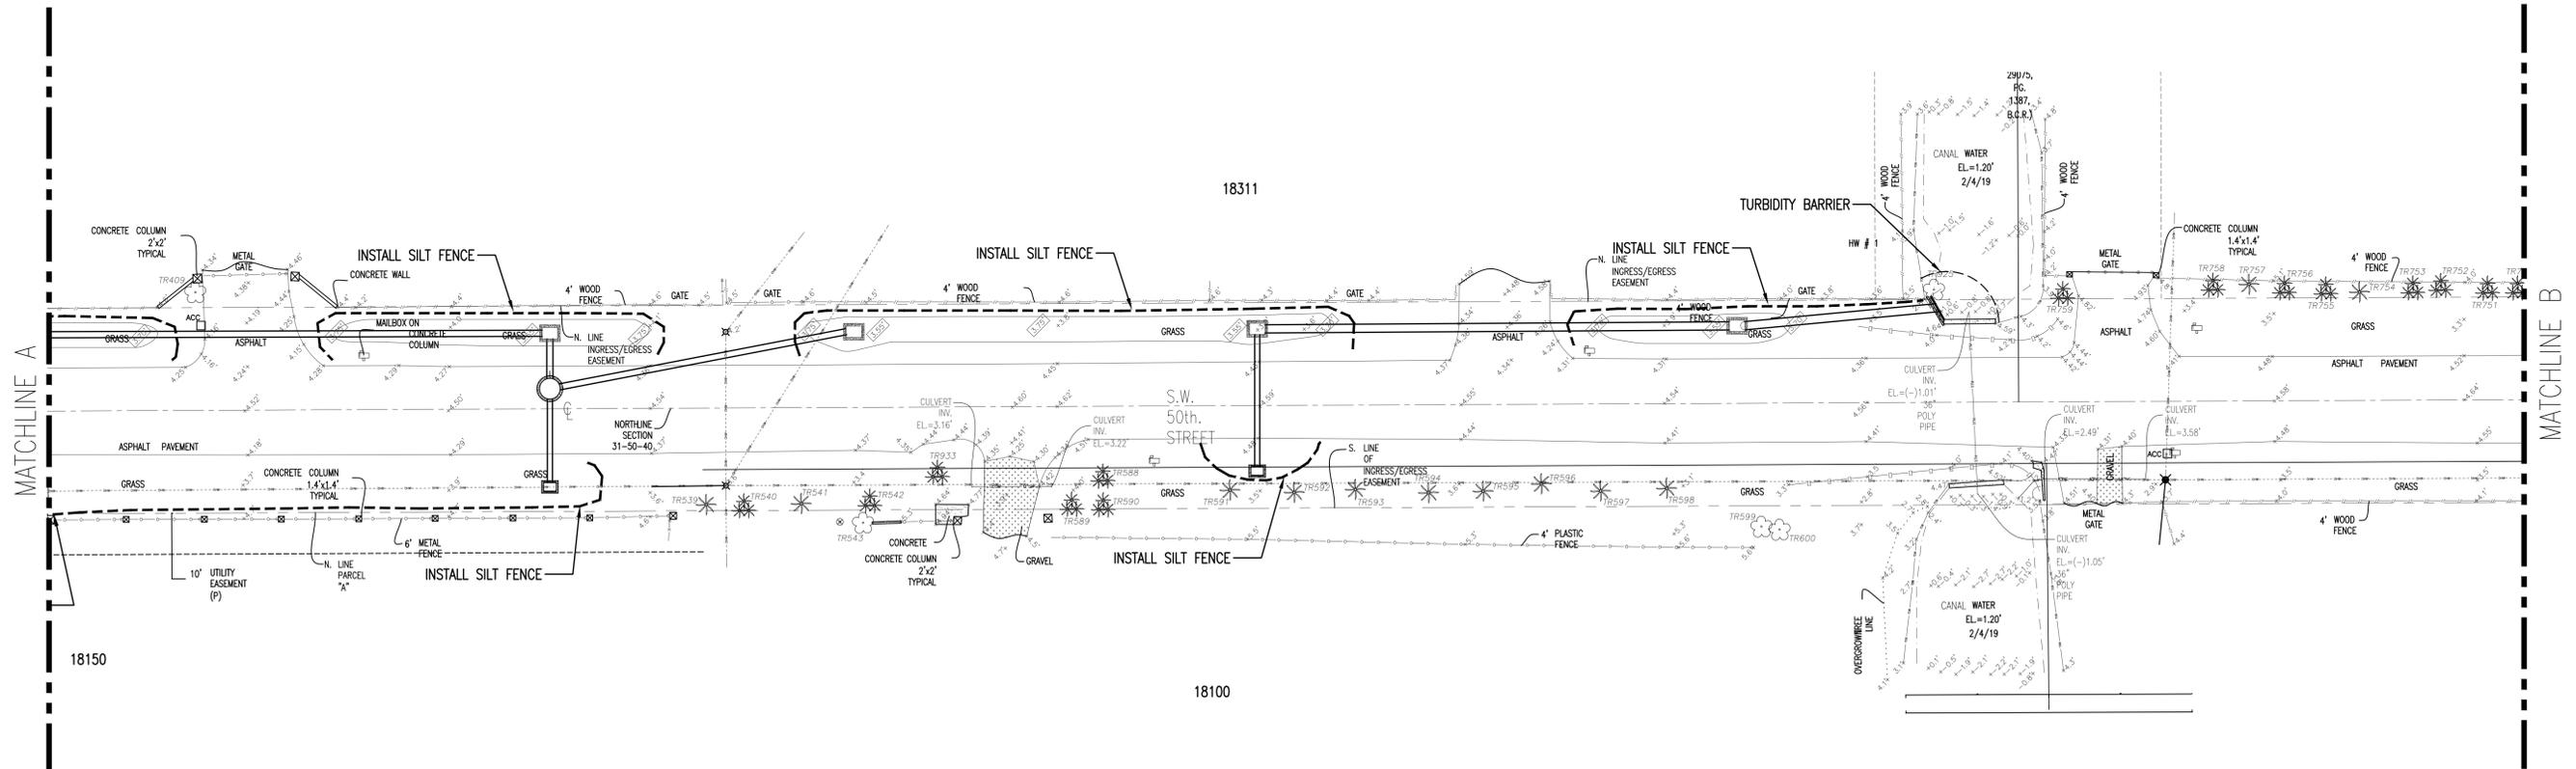

EROSION CONTROL PLAN



SCALE: 1"=20'-0"

NO	DATE	REVISION	BY	NO	DATE	REVISION	BY
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SOUTH BROWARD DRAINAGE DISTRICT
 6591 SW 160th AVE
 SOUTHWEST RANCHES, FL. 33331


EROSION CONTROL PLAN
 S.W. 50th STREET/S.W. 182ns TERRACE IMPROVEMENT PROJECT
 SOUTHWEST RANCHES, FLORIDA

DRAWN BY:
 J.K.S.
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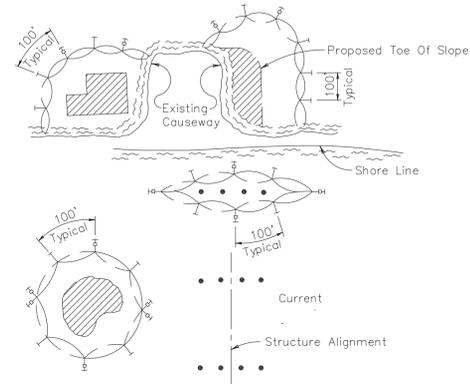
SHEET
5 OF **8**




D₁ = 5' Std. (Single Panel For Depths 5' or Less).
 D₂ = 5' Std. (Additional Panel For Depths 5').
 Curtain To Reach Bottom Up To Depths Of 10 Feet.
 Two(2) Panels To Be Used For Depths Greater Than
 10 Feet Unless Special Depth Curtains Specifically Called
 For In The Plans Or As Determined By The Engineer.

NOTICE: COMPONENTS OF TYPES ~ AND ~ MAY BE SIMILAR OR IDENTICAL TO PROPRIETARY DESIGNS. ANY INFRINGEMENT ON THE PROPRIETARY RIGHTS OF THE DESIGNER SHALL BE THE SOLE RESPONSIBILITY OF THE USER. SUBSTITUTIONS FOR TYPES ~ AND ~ SHALL BE AS APPROVED BY THE ENGINEER.

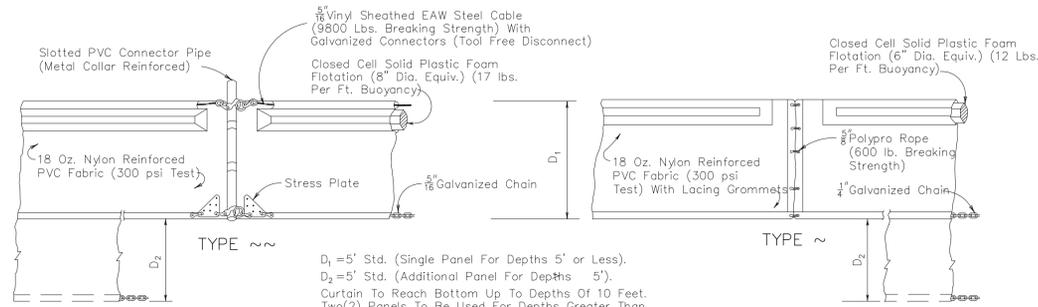FLOATING TURBIDITY BARRIERS





- LEGEND**
- Pile Locations
 - ▨ Dredge Or Fill Area
 - ⊙ Mooring Buoy w/Anchor
 - Anchor
 - Barrier Movement Due To Current Action

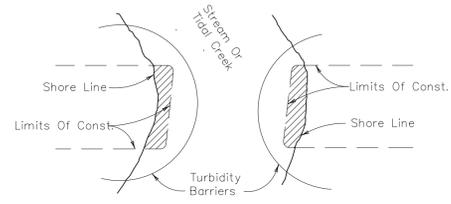

- NOTES:**
1. Turbidity barriers are to be used in all permanent bodies of water regardless of water depth.
 2. Number and spacing of anchors dependent on current velocities.
 3. Deployment of barrier around pile locations may vary to accommodate construction operations.
 4. Navigation may require segmenting barrier during construction operations.
 5. For additional information see Section 104 of the Standard Specifications.


Note:
 Turbidity barriers for flowing streams and tidal creeks may be either floating or staked types or any combinations of types that will suit site conditions and meet erosion control and water quality requirements. The barrier type(s) will be at the Contractors option unless otherwise specified in the plans, however payment will be under the pay item(s) established in the plans for Floating Turbidity Barrier and/or Staked Turbidity Barrier. Posts in staked turbidity barriers to be installed in vertical position unless otherwise directed by the Engineer.

TURBIDITY BARRIER APPLICATIONS

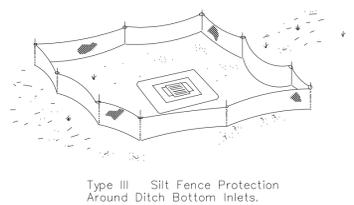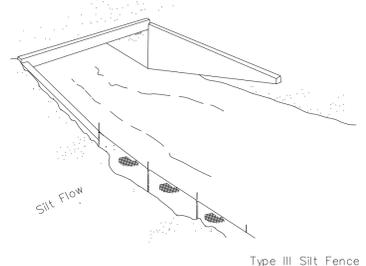


Do not deploy in a manner that silt fences will act as a dam across permanent flowing watercourses. Silt fences are to be used at upland locations and turbidity barriers used at permanent bodies of water.

SILT FENCE APPLICATIONS

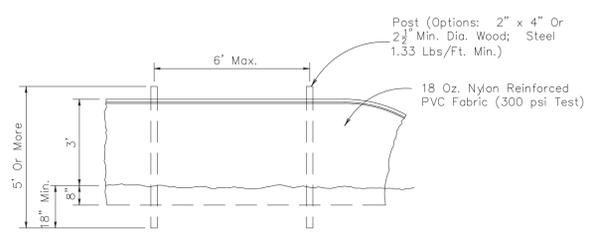

STAKED TURBIDITY BARRIER

- GENERAL NOTES**
1. Floating turbidity barriers are to be paid for under the contract unit price for Floating Turbidity Barrier, LF.
 2. Staked turbidity barriers are to be paid for under the contract unit price for Staked Turbidity Barrier, LF.

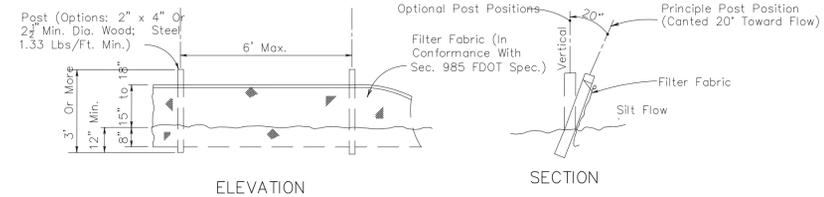

Note: Silt Fence to be paid for under the contract unit price for Staked Silt Fence (LF).


TYPE III SILT FENCE

NO	DATE	REVISION	BY	NO	DATE	REVISION	BY
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SOUTH BROWARD DRAINAGE DISTRICT
 6591 SW 160th AVE
 SOUTHWEST RANCHES, FL. 33331

EROSION CONTROL DETAILS
S.W. 50th STREET/S.W. 182nd TERRACE IMPROVEMENT PROJECT
SOUTHWEST RANCHES, FL.

DRAWN BY:
 J.K.S.
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 K.M.H.
 DATE 5-24-19

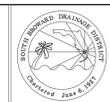

SCALE
 AS NOTED
 PROJECT No
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SHEET
 6 OF 8

SKETCH OF TOPOGRAPHIC AND SPECIFIC PURPOSE (TREE) SURVEY

ABBREVIATIONS



B.C.R.	BROWARD COUNTY RECORDS
B.O.S.E.	BOTTOM OF STRUCTURE ELEVATION
CL	CENTER LINE
CB	CATCH BASIN
C.B.S.	CONCRETE BLOCK STRUCTURE
CMP	CORRUGATED METAL PIPE
CONC.	CONCRETE
D.C.R.	DADE COUNTY RECORDS
D.E.	DRAINAGE EASEMENT
DIAM.	DIAMETER
D.M.E.	DRAINAGE MAINTENANCE EASEMENT
EL	ELEVATION
ELEC.	ELECTRIC
EQUIP.	EQUIPMENT
F.F.E.	FINISHED FLOOR ELEVATION
FND.	FOUND
FPL	FLORIDA POWER & LIGHT
HDPE	HIGH DENSITY POLY ETHYLENE
ID.	IDENTIFICATION
I.E.E.	INGRESS/EGRESS EASEMENT
INV.	INVERT ELEVATION
LB	LICENSED BUSINESS
L.M.E.	LAKE MAINTENANCE EASEMENT
L.B.M.E.	LAKE BANK MAINTENANCE EASEMENT
M.D.C.R.	MIAMI-DADE COUNTY RECORDS
MH	MANHOLE
MHD	MANHOLE DRAINAGE
MHS	MANHOLE SEWER
N/D	NAIL & DISC
O.R.B.	OFFICIAL RECORDS BOOK
P.B.	PLAT BOOK
PCP	PERMANENT CONTROL POINT
PG	PAGE
P/M	PLAT AND MEASURED
P.O.B.	POINT OF BEGINNING
P.O.C.	POINT OF COMMENCEMENT
PRD	POLLUTION RETARDANT DEVICE
PRM	PERMANENT REFERENCE MONUMENT
PT.	POINT
PVC	POLYVINYL CHLORIDE
R	RADIUS
RCP	REINFORCED CONCRETE PIPE
R.E.	RIM ELEVATION
R/W	RIGHT-OF-WAY
TR	TREE NUMBER
TRAV.	TRAVERSE
TYP.	TYPICAL
U.E.	UTILITY EASEMENT
VCP	VITRIFIED CLAY PIPE

LEGEND

	ELECTRIC MANHOLE
	GREASE TRAP MANHOLE
	SANITARY SEWER MANHOLE
	METAL LIGHT POLE
	METAL POST
	PALM
	PALM CLUSTER
	PLASTIC POST
	SINGLE SUPPORT SIGN
	STUMP
	TELEPHONE RISER
	TRASH - GARBAGE BIN
	TREE
	TREE CLUSTER
	TELEPHONE VAULT
	TRANSFORMER ON PAD
	UTILITY POLE
	GAS VALVE
	IRRIGATION VALVE
	SEWER VALVE
	UNKNOWN VALVE
	WATER VALVE
	COMMUNICATIONS VAULT
	ELECTRIC VAULT
	FIBER OPTIC VAULT
	UNKNOWN UTILITY VAULT
	WIRE PULL BOX
	ELECTRIC WIRE PULL BOX
	STREET LIGHT WIRE PULL BOX
	TELEPHONE WIRE PULL BOX
	SANITARY TRAFFIC WIRE PULL BOX
	WATER METER
	YARD DRAIN
	ROUND INLET
	TELEPHONE RISER

LEGEND

	AIR CONDITIONER
	BACK FLOW PREVENTER
	BENCH
	BOLLARD
	CABLE TV BOX
	CABLE TV RISER
	CABLE TV VAULT
	CATCH BASIN
	CLEANOUT
	CONCRETE LIGHT POLE
	CONCRETE POWER POLE
	DOUBLE SUPPORT SIGN
	DRINKING FOUNTAIN
	DOUBLE VALVE ASSEMBLY
	ELECTRIC CABINET
	ELECTRIC METER
	ELECTRIC OUTLET
	ELECTRIC VAULT
	FIRE DEPARTMENT CONNECTION
	FIRE HYDRANT
	FLAG POLE
	GAS BOX
	GAS METER
	GUTTER INLET
	GROUND LIGHT
	HANDICAP
	HIGH MAST LIGHT POLE
	IRRIGATION BOX
	IRRIGATION PUMP
	LIGHTED BOLLARD
	MAIL BOX
	STORM DRAINAGE MANHOLE
	SPOT ELEVATION (HARD SURFACE)
	SPOT ELEVATION (SOFT SURFACE)
	12 INCHES CORRUGATED METAL PIPE
	8 INCHES POLY VINYL CHLORIDE PIPE
	STORM SEWER PIPE
	BREAK IN LINE SCALE
	OVERHEAD WIRES
	TREE/HEDGE LINE

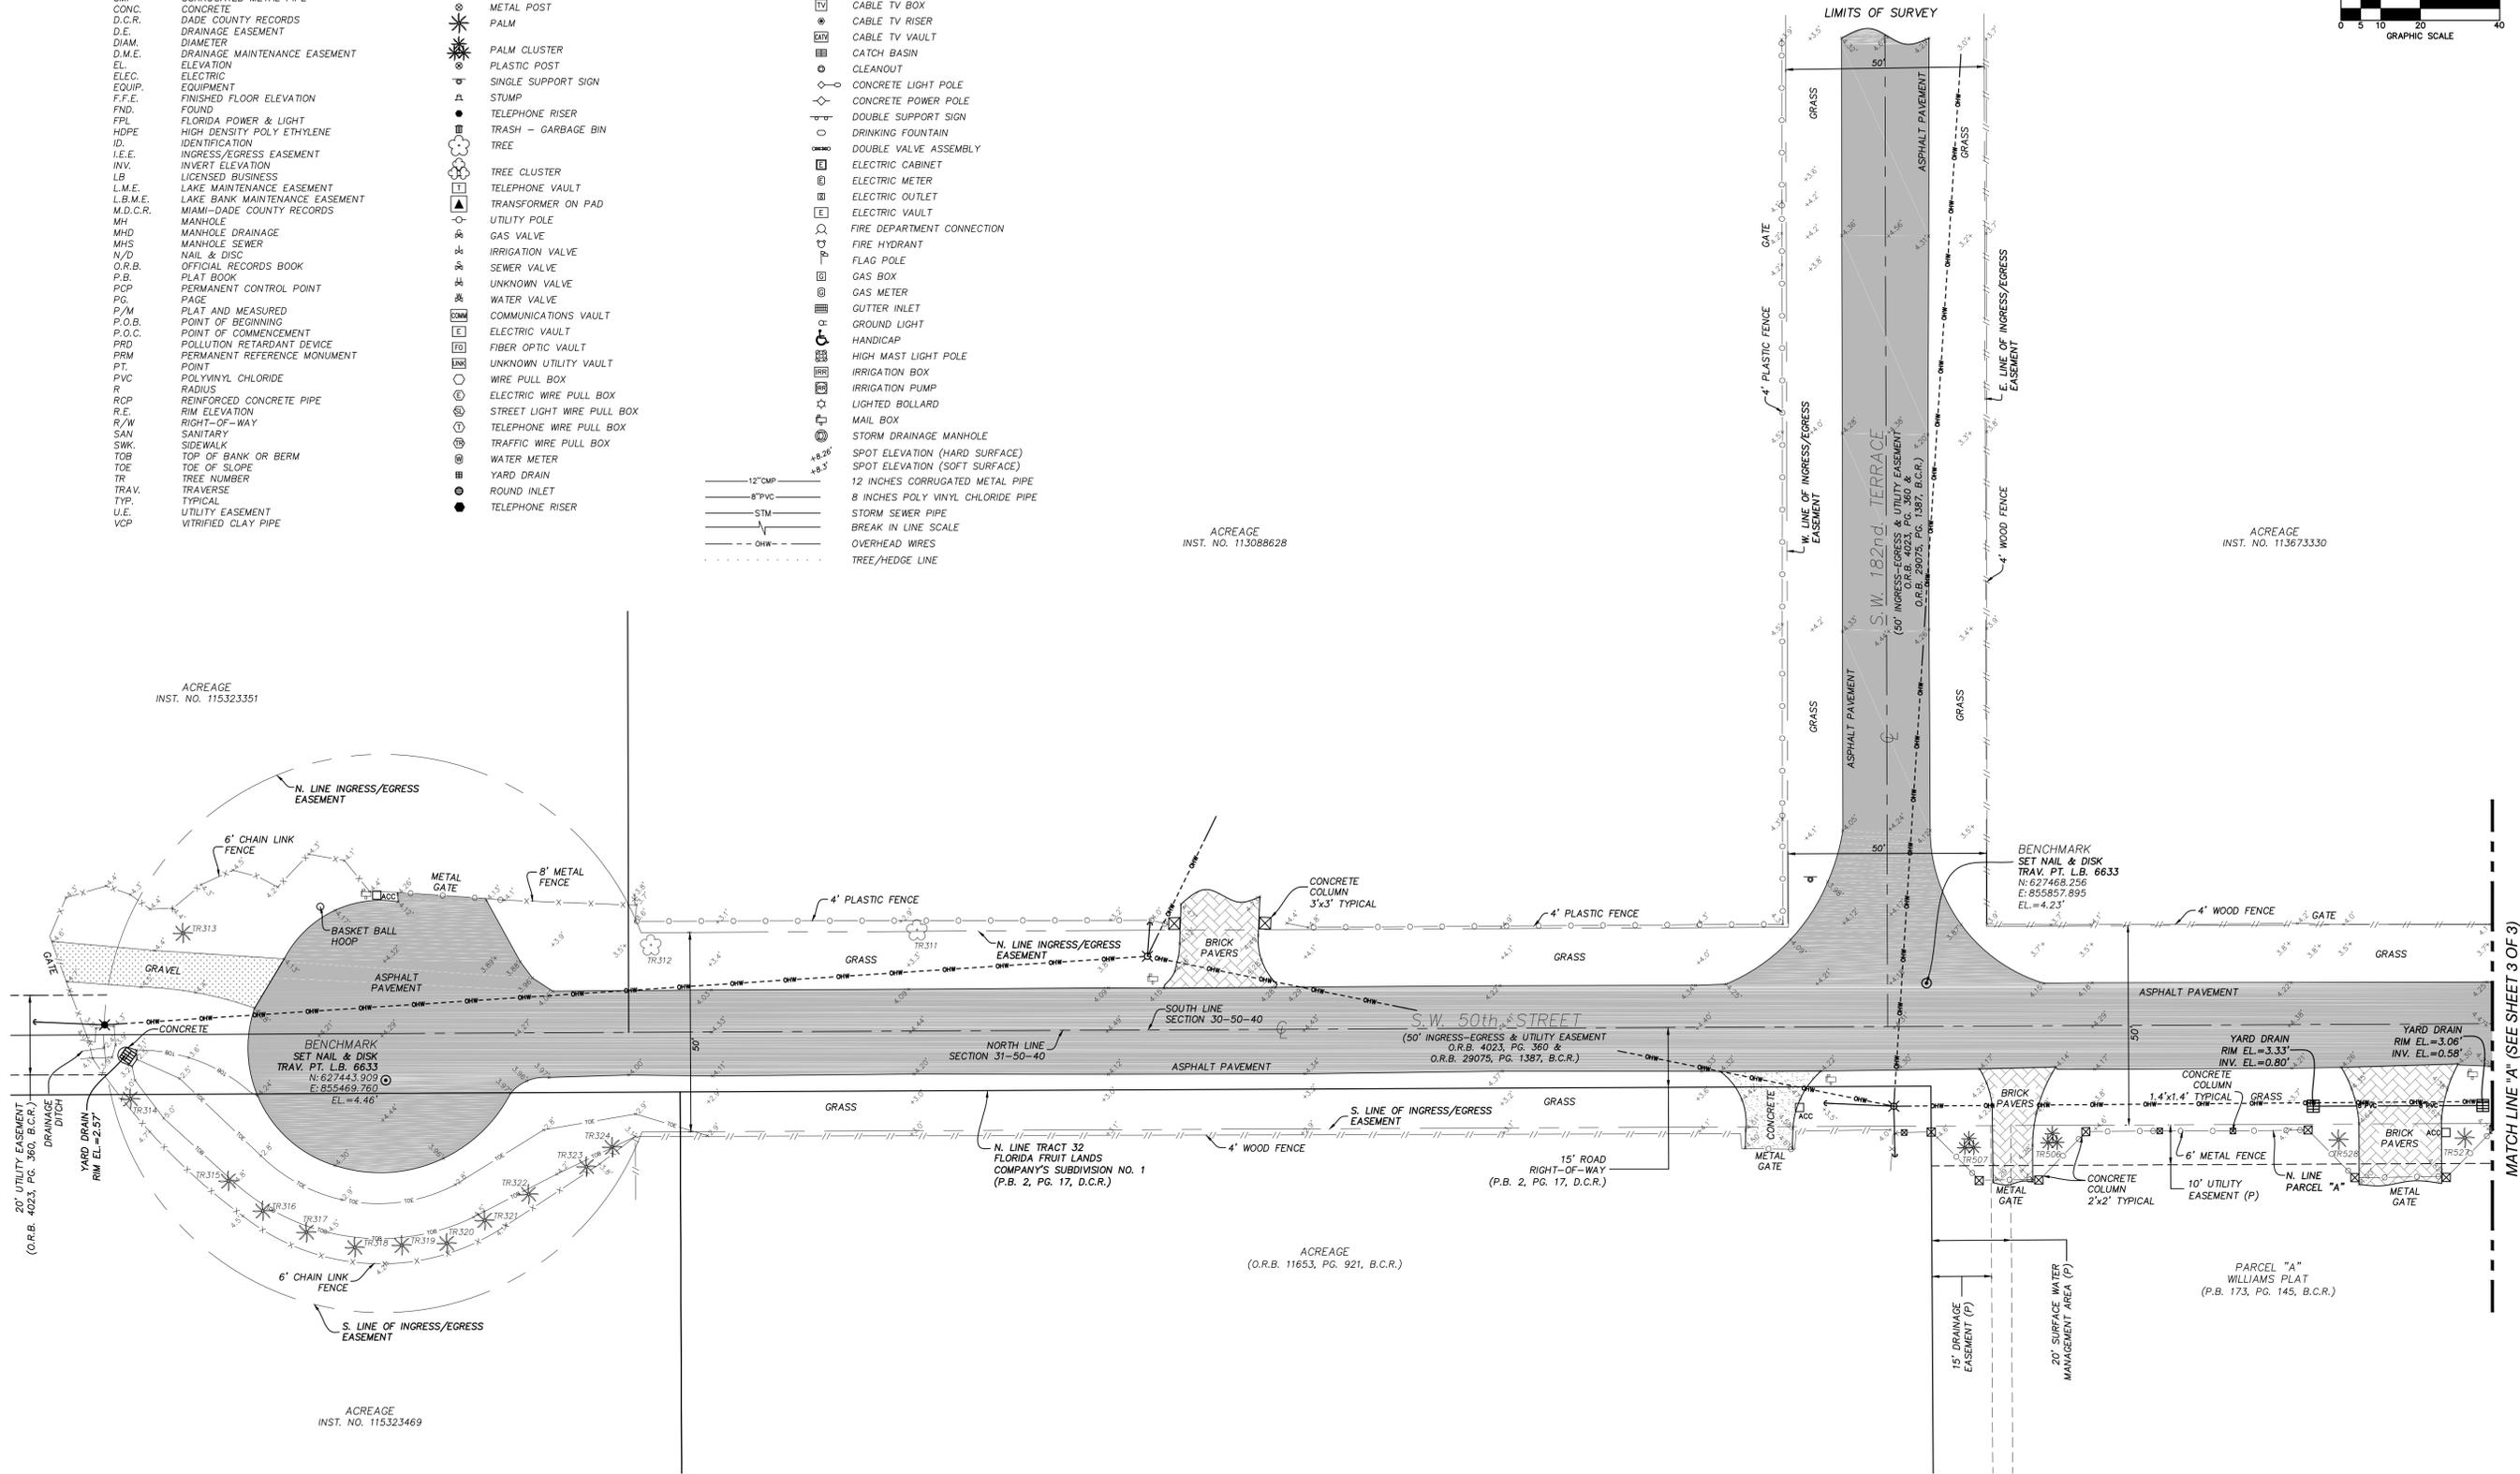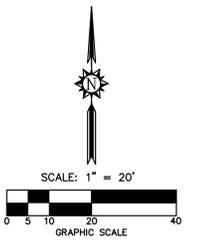

NO.	REVISION	DATE	BY:
<p>STONER & ASSOCIATES, Inc. SURVEYORS - MAPPERS Florida Licensed Surveying and Mapping Business No. 6633 4341 S.W. 62nd AVENUE, TOWN OF DAVIE, FLORIDA 33314</p>			
<p>SKETCH OF TOPOGRAPHIC AND SPECIFIC PURPOSE (TREE) SURVEY ROLLING OAKS DRAINAGE IMPROVEMENTS ALONG S.W. 50TH STREET AND S.W. 182ND STREET SOUTHWEST RANCHES, FLORIDA 33331</p>			
LAST DATE OF FIELD SURVEY	DRAWN: DWS	CHECKED: JDS	BOOK/PAGE(S): 91/146 & DATA COLLECTOR
2/4/19			
<p>SEAL</p> <p>JAMES D. STONER PROFESSIONAL SURVEYOR AND MAPPER NO. 4039 STATE OF FLORIDA</p>			
<p>PROJECT 19-8810</p>			
<p>SHEET NO. 1 OF 2</p>			

