
TOWN OF SOUTHWEST RANCHES, FLORIDA DRAINAGE IMPROVEMENTS FOR **GREEN MEADOWS DYKES ROAD DRAINAGE** IFB NO. 22-006

EXHIBIT A – DRAWINGS

TOWN OF SOUTHWEST RANCHES & SOUTH BROWARD DRAINAGE DISTRICT S.W. 54th PLACE/DYKES ROAD DRAINAGE IMPROVEMENTS

TOWN OF SOUTHWEST RANCHES 13400 GRIFFIN ROAD SOUTHWEST RANCHES, FLORIDA 33330



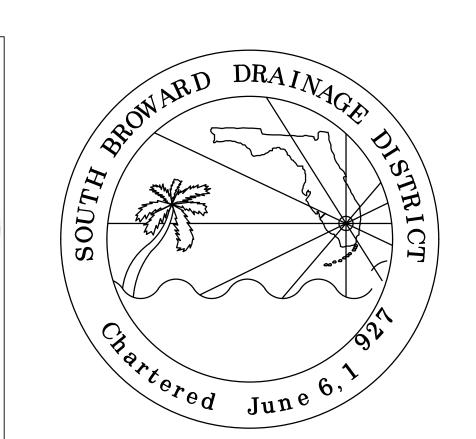

SOUTH BROWARD DRAINAGE DISTRICT 6591 SW 160th AVE.
SOUTHWEST RANCHES, FLORIDA 33331





DRAWING INDEX:


		X •
COVER SHEET		
54 PI & Dykes Rd PAVING & DRAINAGE PLAN 1	_	1
54 PI & Dykes Rd PAVING & DRAINAGE PLAN 2	_	2
54 PI & Dykes Rd PAVING & DRAINAGE PLAN 3	_	3
54 PI & Dykes Rd PAVING & DRAINAGE PLAN 4	_	4
54 PI & Dykes Rd EROSION CONTROL PLAN 1	_	5
54 PI & Dykes Rd EROSION CONTROL PLAN 2	_	6
54 PI & Dykes Rd EROSION CONTROL PLAN 3	_	7
54 PI & Dykes Rd EROSION CONTROL PLAN 4	_	8
EROSION CONTROL DETAILS	_ _ _	10


TOWN OF SOUTHWEST RANCHES COUNCIL:

Steve Breitkrevz (Mayor)
Gary Jablonski (Council Member)
Jim Allbritton (Council Member)
David Kuczenski (Council Member)
Robert Hartman (Council Member)

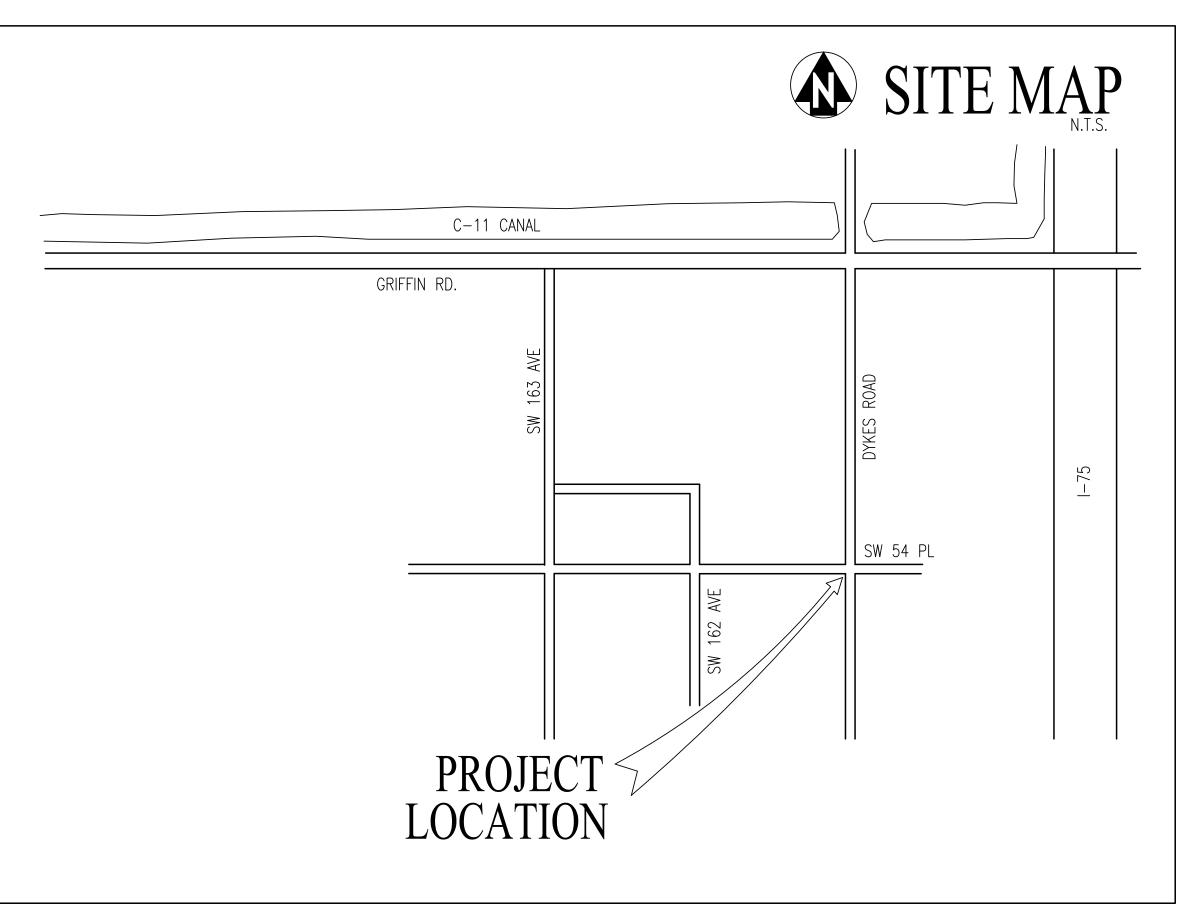

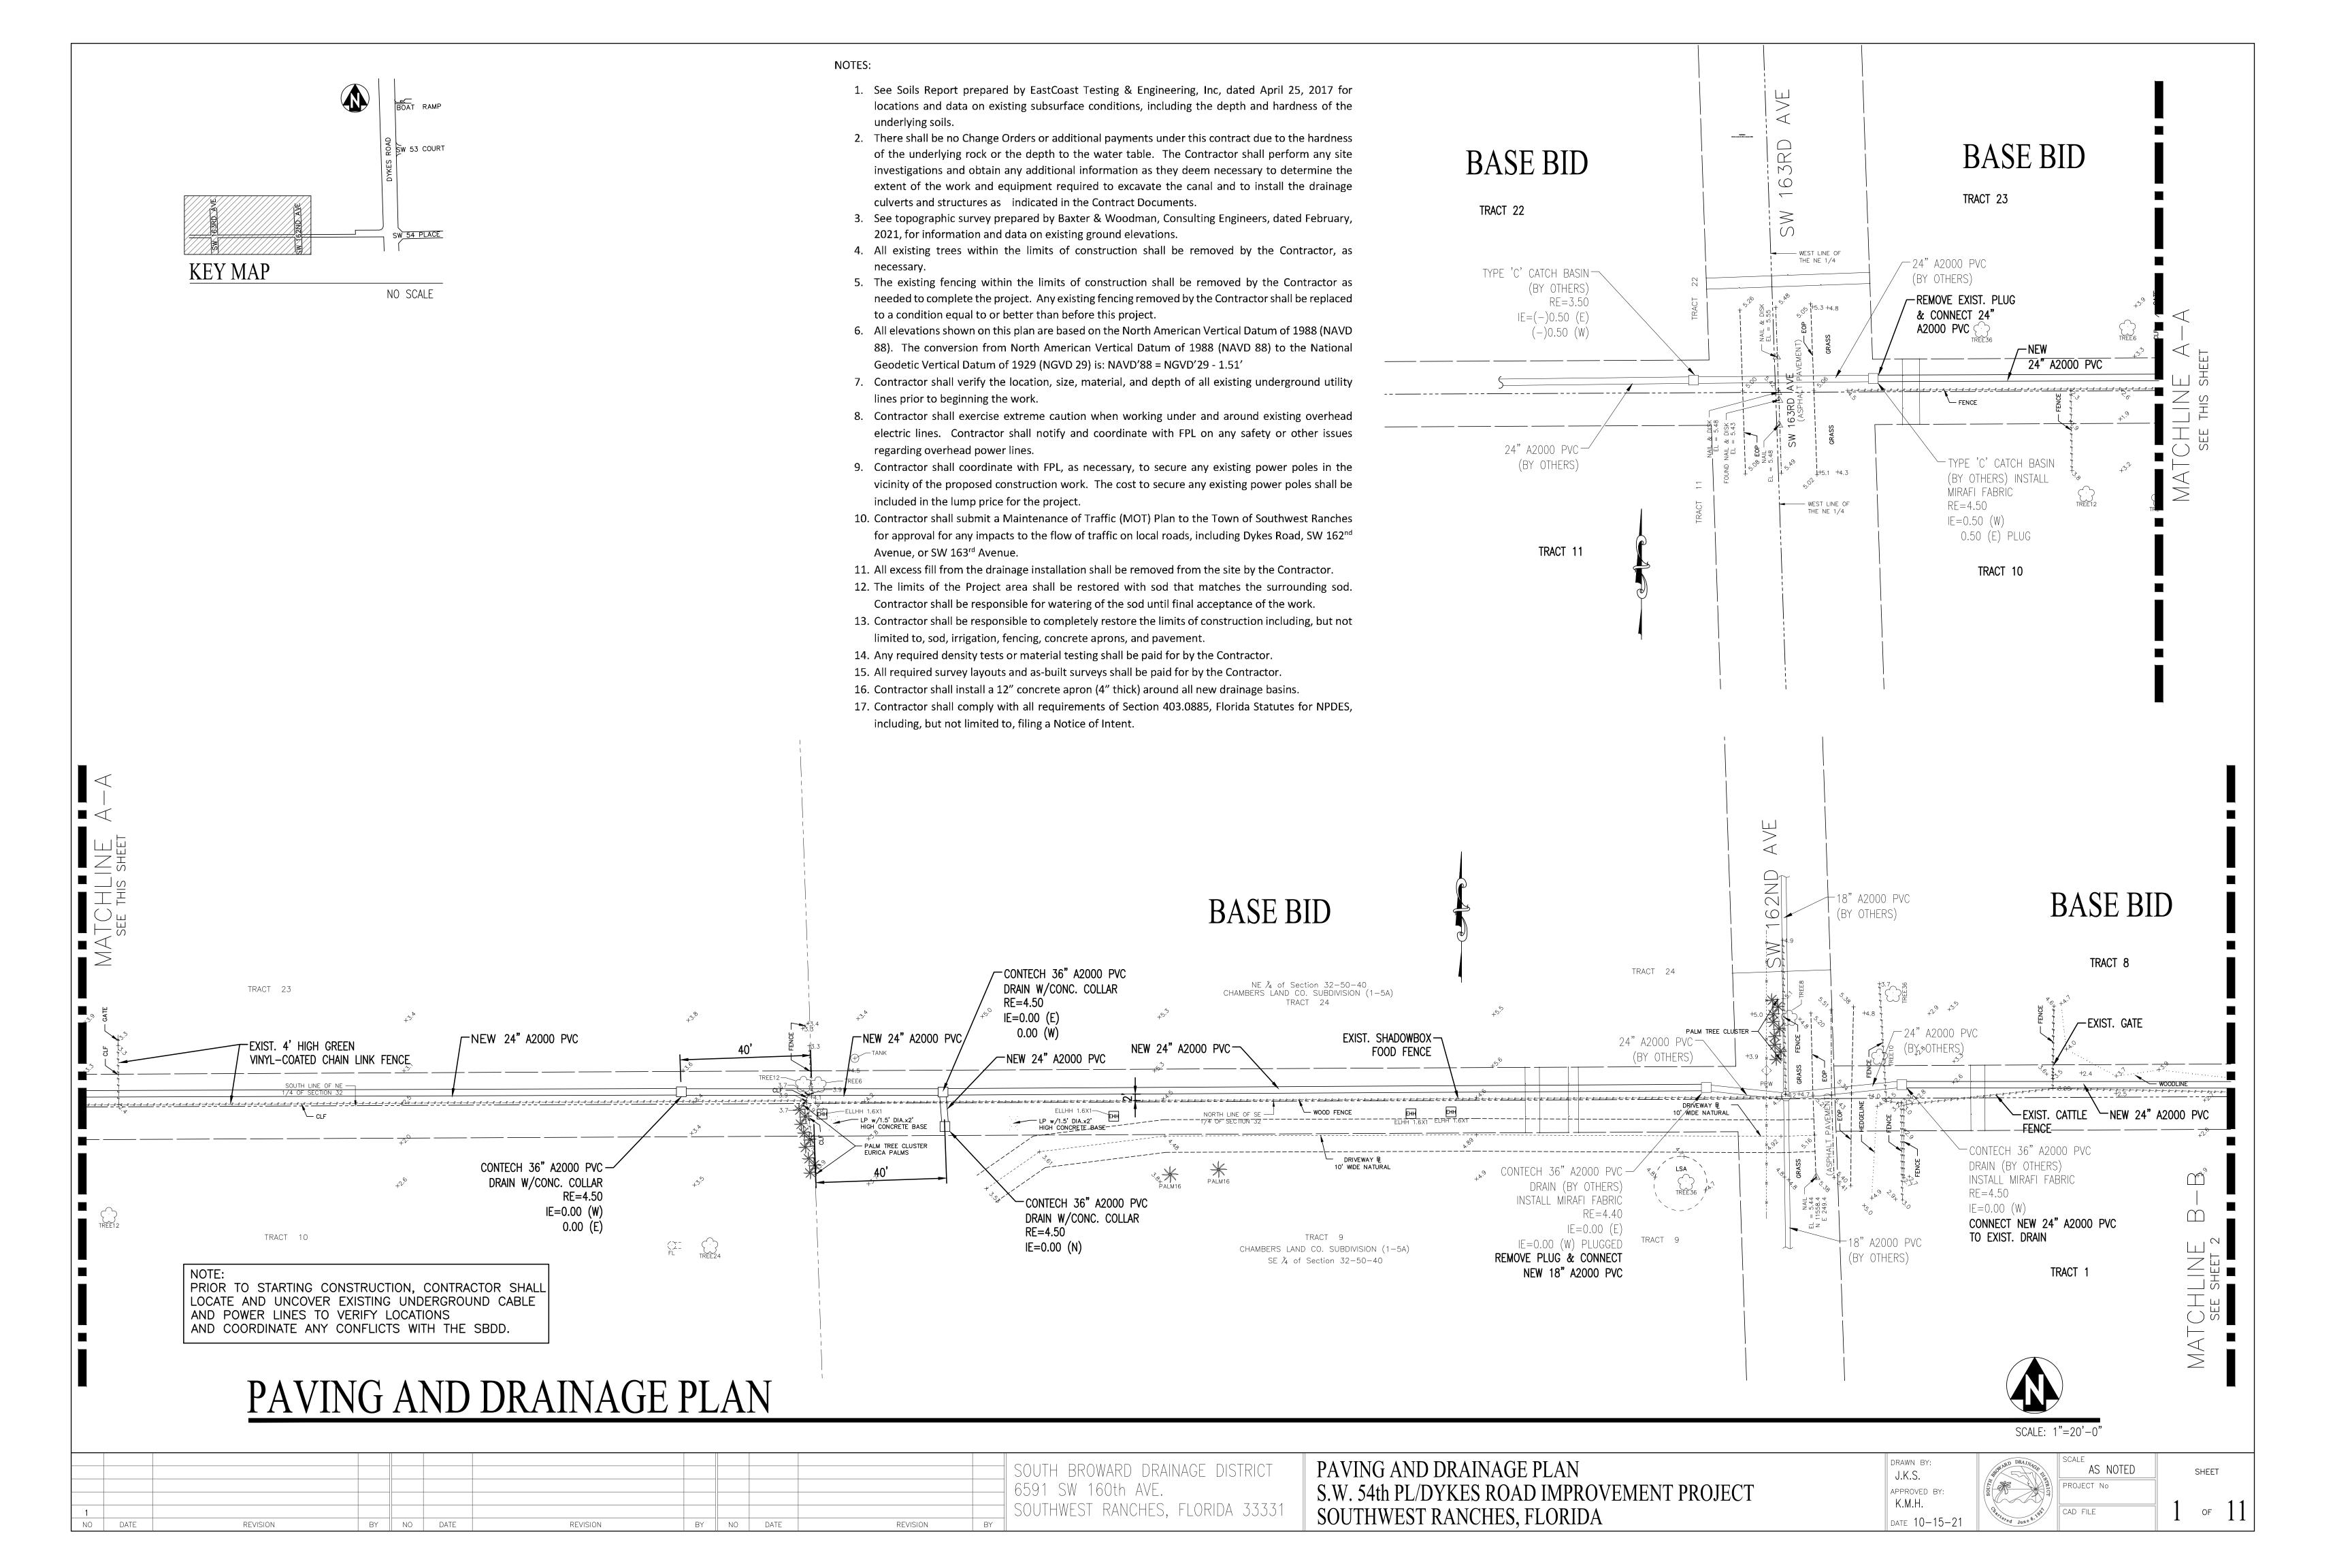

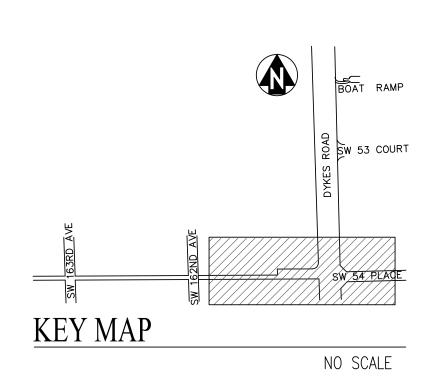

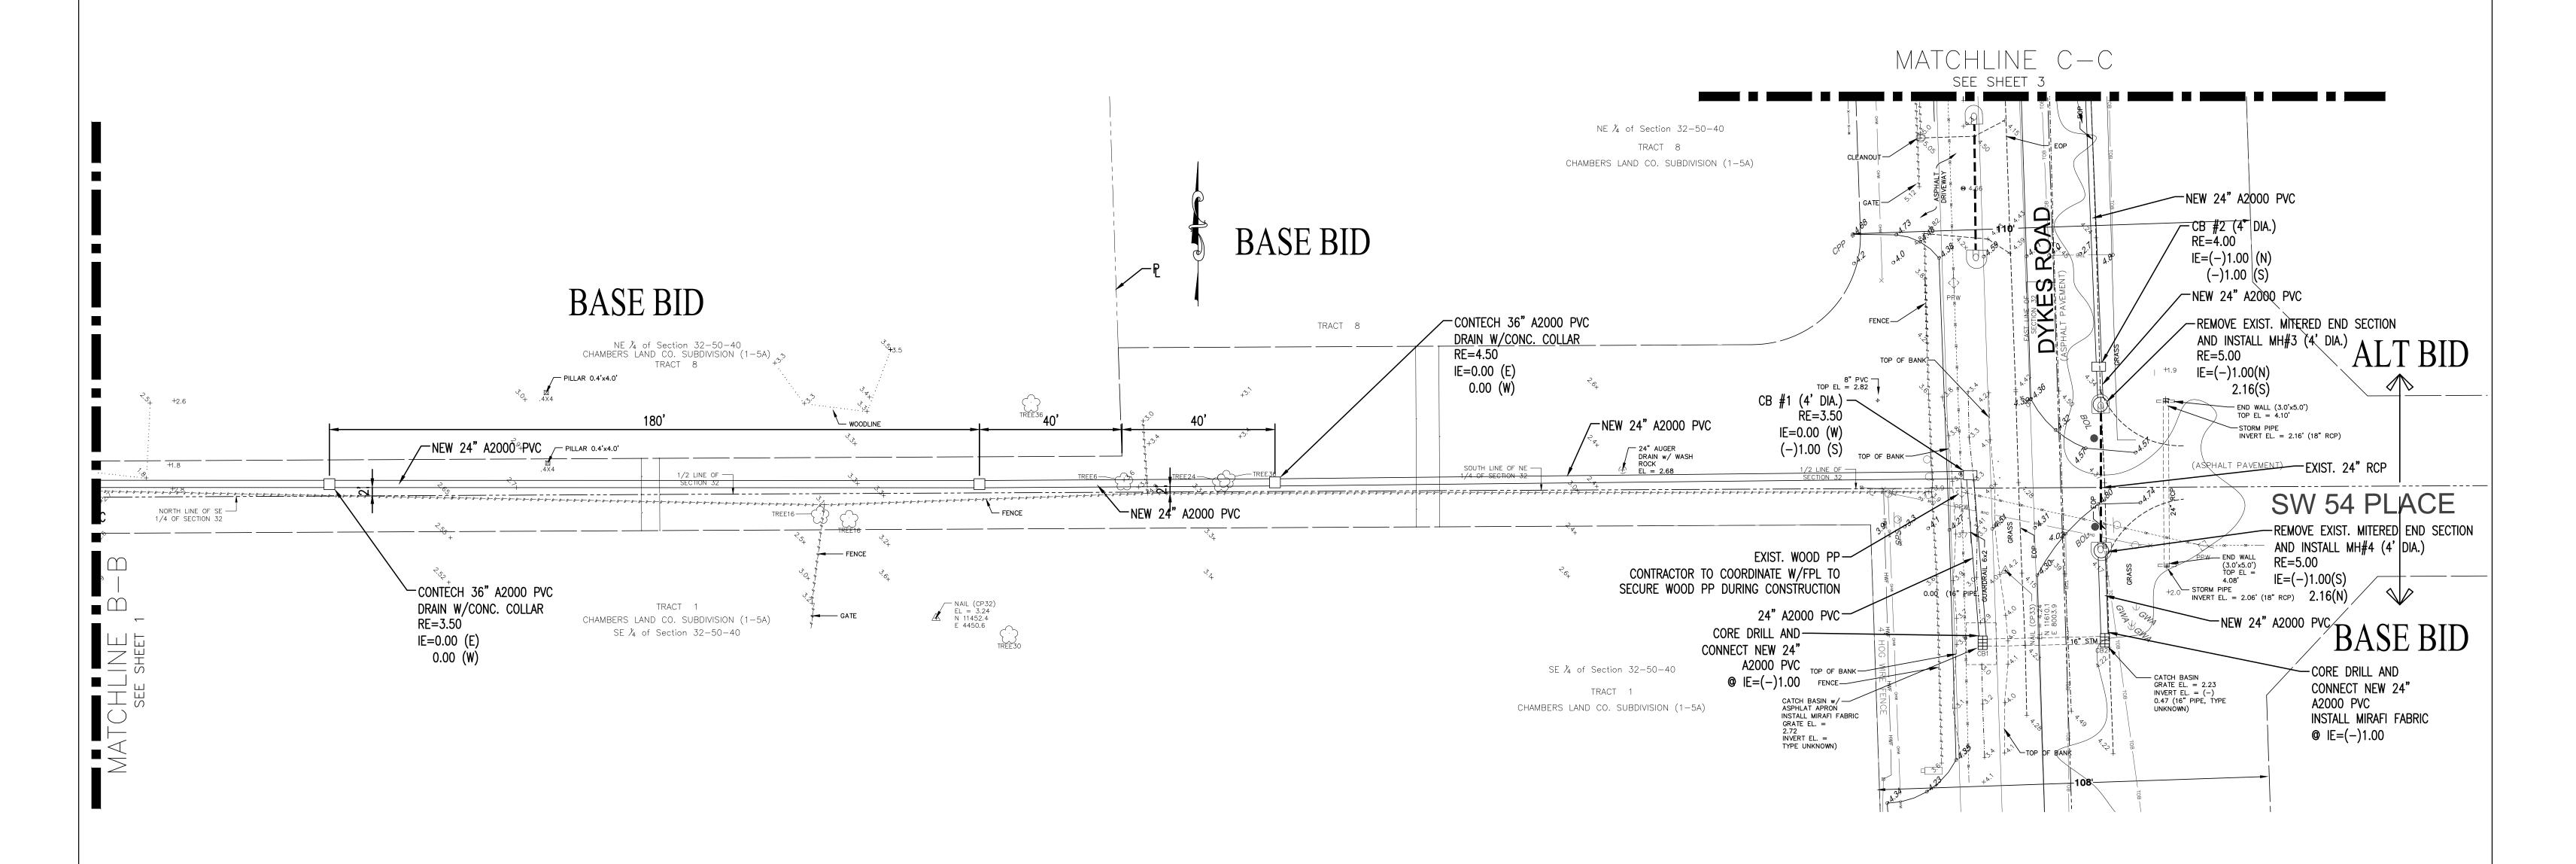


NOTE:
PRIOR TO STARTING CONSTRUCTION, CONTRACTOR SHALL
LOCATE AND UNCOVER EXISTING UNDERGROUND CABLE
AND POWER LINES TO VERIFY LOCATIONS
AND COORDINATE ANY CONFLICTS WITH THE SBDD.

PAVING AND DRAINAGE PLAN



SCALE: 1"=20'-0"

			SOUTH BROWARD DRAINAGE DISTRICT	PAVING AND DRAINAGE PLAN	DRAWN BY:	SCALE AS NOTED	SHEET
			6591 SW 160th AVE.	S.W. 54th PL/DYKES ROAD IMPROVEMENT PROJECT	APPROVED BY:	PROJECT No	
1 NO DATE REVISION BY	NO DATE REVISION BY N	DATE REVISION BY	SUUTHWEST RANCHES, FLORIDA 33331	SOUTHWEST RANCHES, FLORIDA	DATE 10-15-21	CAD FILE	Z OF II

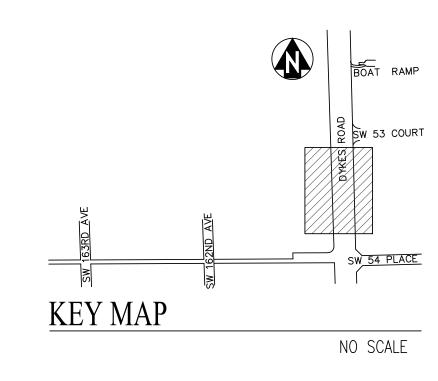


PRIOR TO STARTING CONSTRUCTION, CONTRACTOR SHALL LOCATE AND UNCOVER EXISTING UNDERGROUND CABLE AND POWER LINES TO VERIFY LOCATIONS AND COORDINATE ANY CONFLICTS WITH THE SBDD.

PAVING AND DRAINAGE PLAN

1											
l no	DATE	REVISION	BY	l no l	DATE	REVISION	BY	ll NO	DATE	REVISION BY	

SOUTH BROWARD 6591 SW 160th / SOUTHWEST RANG

FLA FRUIT LANDS CO SUB NO 1, P.B 2, PAGE 17
SECTION 33, TOWNSHIP 50 SOUTH, RANGE 40 EAST
TRACT 25 LESS EAST 1150 FEET
& LESS RIGHT OF-WAY
FOR SW 160 AVE & FOR SW 54 PLACE

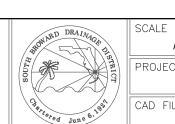

RD DRAINAGE DISTRICT	PAVING AND DRAINAGE PLAN	DRAWN BY: J.K.S.	AS NOTED	SHEET
h AVE. NCHES, FLORIDA 33331	S.W. 54th PL/DYKES ROAD IMPROVEMENT PROJECT SOUTHWEST RANCHES, FLORIDA	APPROVED BY: K.M.H. DATE 10-15-21	PROJECT No CAD FILE	3 of 11

MATCHLINE C-C see sheet 2

MATCHLINE D-D

SEE SHEET 4

RIGHT-OF-WAY

FLA FRUIT LANDS CO SUB NO 1, P.B. 2, PG. 17
SECTION 33, TOWNSHIP 50 SOUTH, RANGE 40 EAST,
TRACT 26, WEST 132 FEET OF EAST 1038 FEET
& TRACT 26 LESS EAST 1170 FEET
& LESS WEST 15 FEET RIGHT-OF-WAY

ALT BID

CONTECH 36" A2000 PVC

DRAIN W/CONC. COLLAR

RE=3.50

IE=(-)1.00(N)

NEW 24" A2000 PVC

CORE DRILL AND

A2000 PVC

EXIST.

CONNECT NEW 24"

(-)1.00(S)

18" CMP W INV. ELEV. = (-)0.41 FEET

─NEW 24" A2000 PVC

(STRUCTURE IS FULL OF WATER & DEBRIS)

(-)1.00(S)

CHAMBERS LAND CO SUB NE1/4, P.B. 1, PG. 5A SECTION 32, TOWNSHIP 50 SOUTH, RANGE 40 EAST TRACT 7 S1/2 LESS EAST 53 FEET FOR ROAD RIGHT-OF-WAY & LESS WEST 297.62 FEET

APPROXIMATE DRIP LINE

RIGHT-OF-WAY —

12" RCP S INV. ELEV. = 2.98 -

12" RCP INV. ELEV. = 2.95 FEET-

18" CMP E INV. ELEV. = 0.04 FEET

(STRUCTURE IS FULL OF WATER & DEBRIS)

CHAMBERS LAND CO SUB NE1/4, P.B. 1, PG. 5A
SECTION 32, TOWNSHIP 50 SOUTH, RANGE 40 EAST
TRACT 8, SOUTH 157.50 FEET LESS WEST 396 FEET
& LESS THAT PART LYING WITHIN 55 FEET OF EAST
LINE OF NE1/4 & WITHIN 40 FEET OF SOUTH LINE OF
NE1/4 & EXTERNAL AREA


NE $\frac{7}{4}$ of Section 32-50-40

BOTTOM ELEV. = 2.52 FEET


BM ELEV. = 3.91 FEET (NVGD88) — IRON ROD & CAP LB6860


RIGHT-OF-WAY —


APPROXIMATE DRIP LINE-

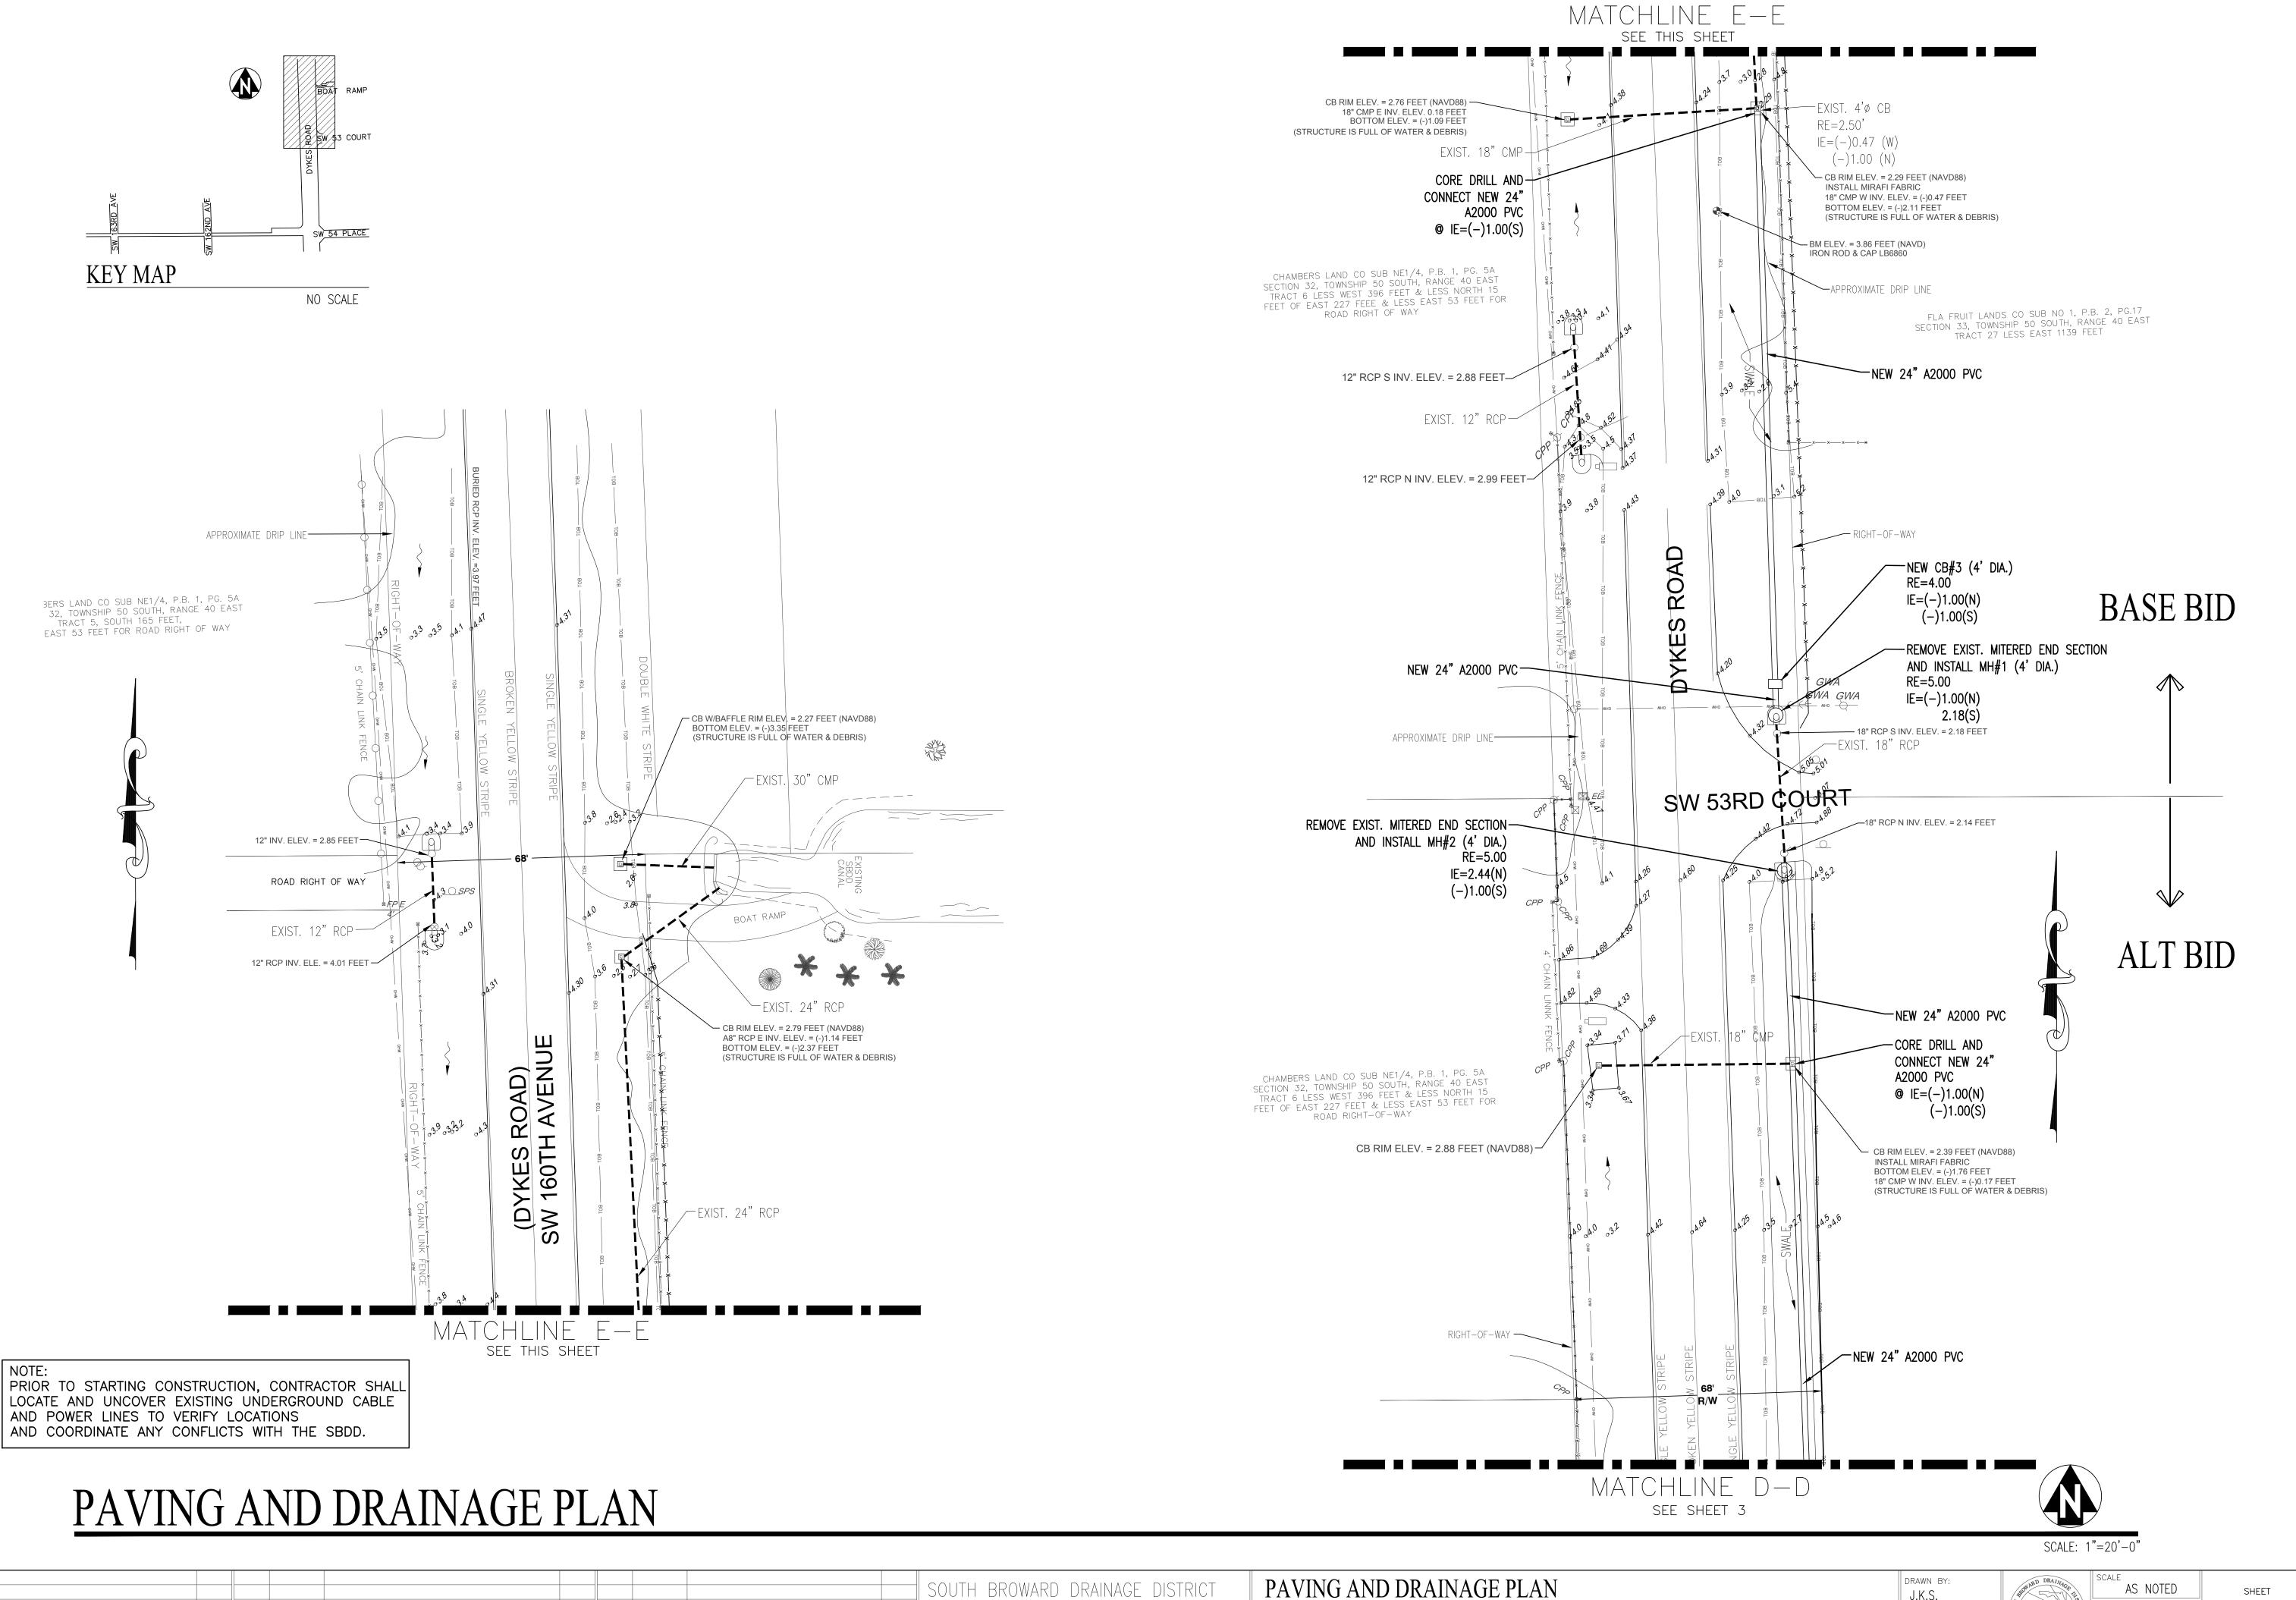

						,	SOUTH BROWARD DRAINAGE DISTRICT	PAVING AND DRAINAGE PLAN	DRAWN BY: J.K.S.	AS NOTED	SHEET
							6591 SW 160th AVE.	S.W. 54th PL/DYKES ROAD IMPROVEMENT PROJECT	APPROVED BY: K.M.H.	PROJECT No	11
1 NO DATE REVISION	BY NO DATE	REVISION	BY	NO DATE	REVISION	BY	SUUTHWEST RANCHES, FLORIDA 33331	SOUTHWEST RANCHES, FLORIDA	DATE 10-15-21	CAD FILE	4 OF 11

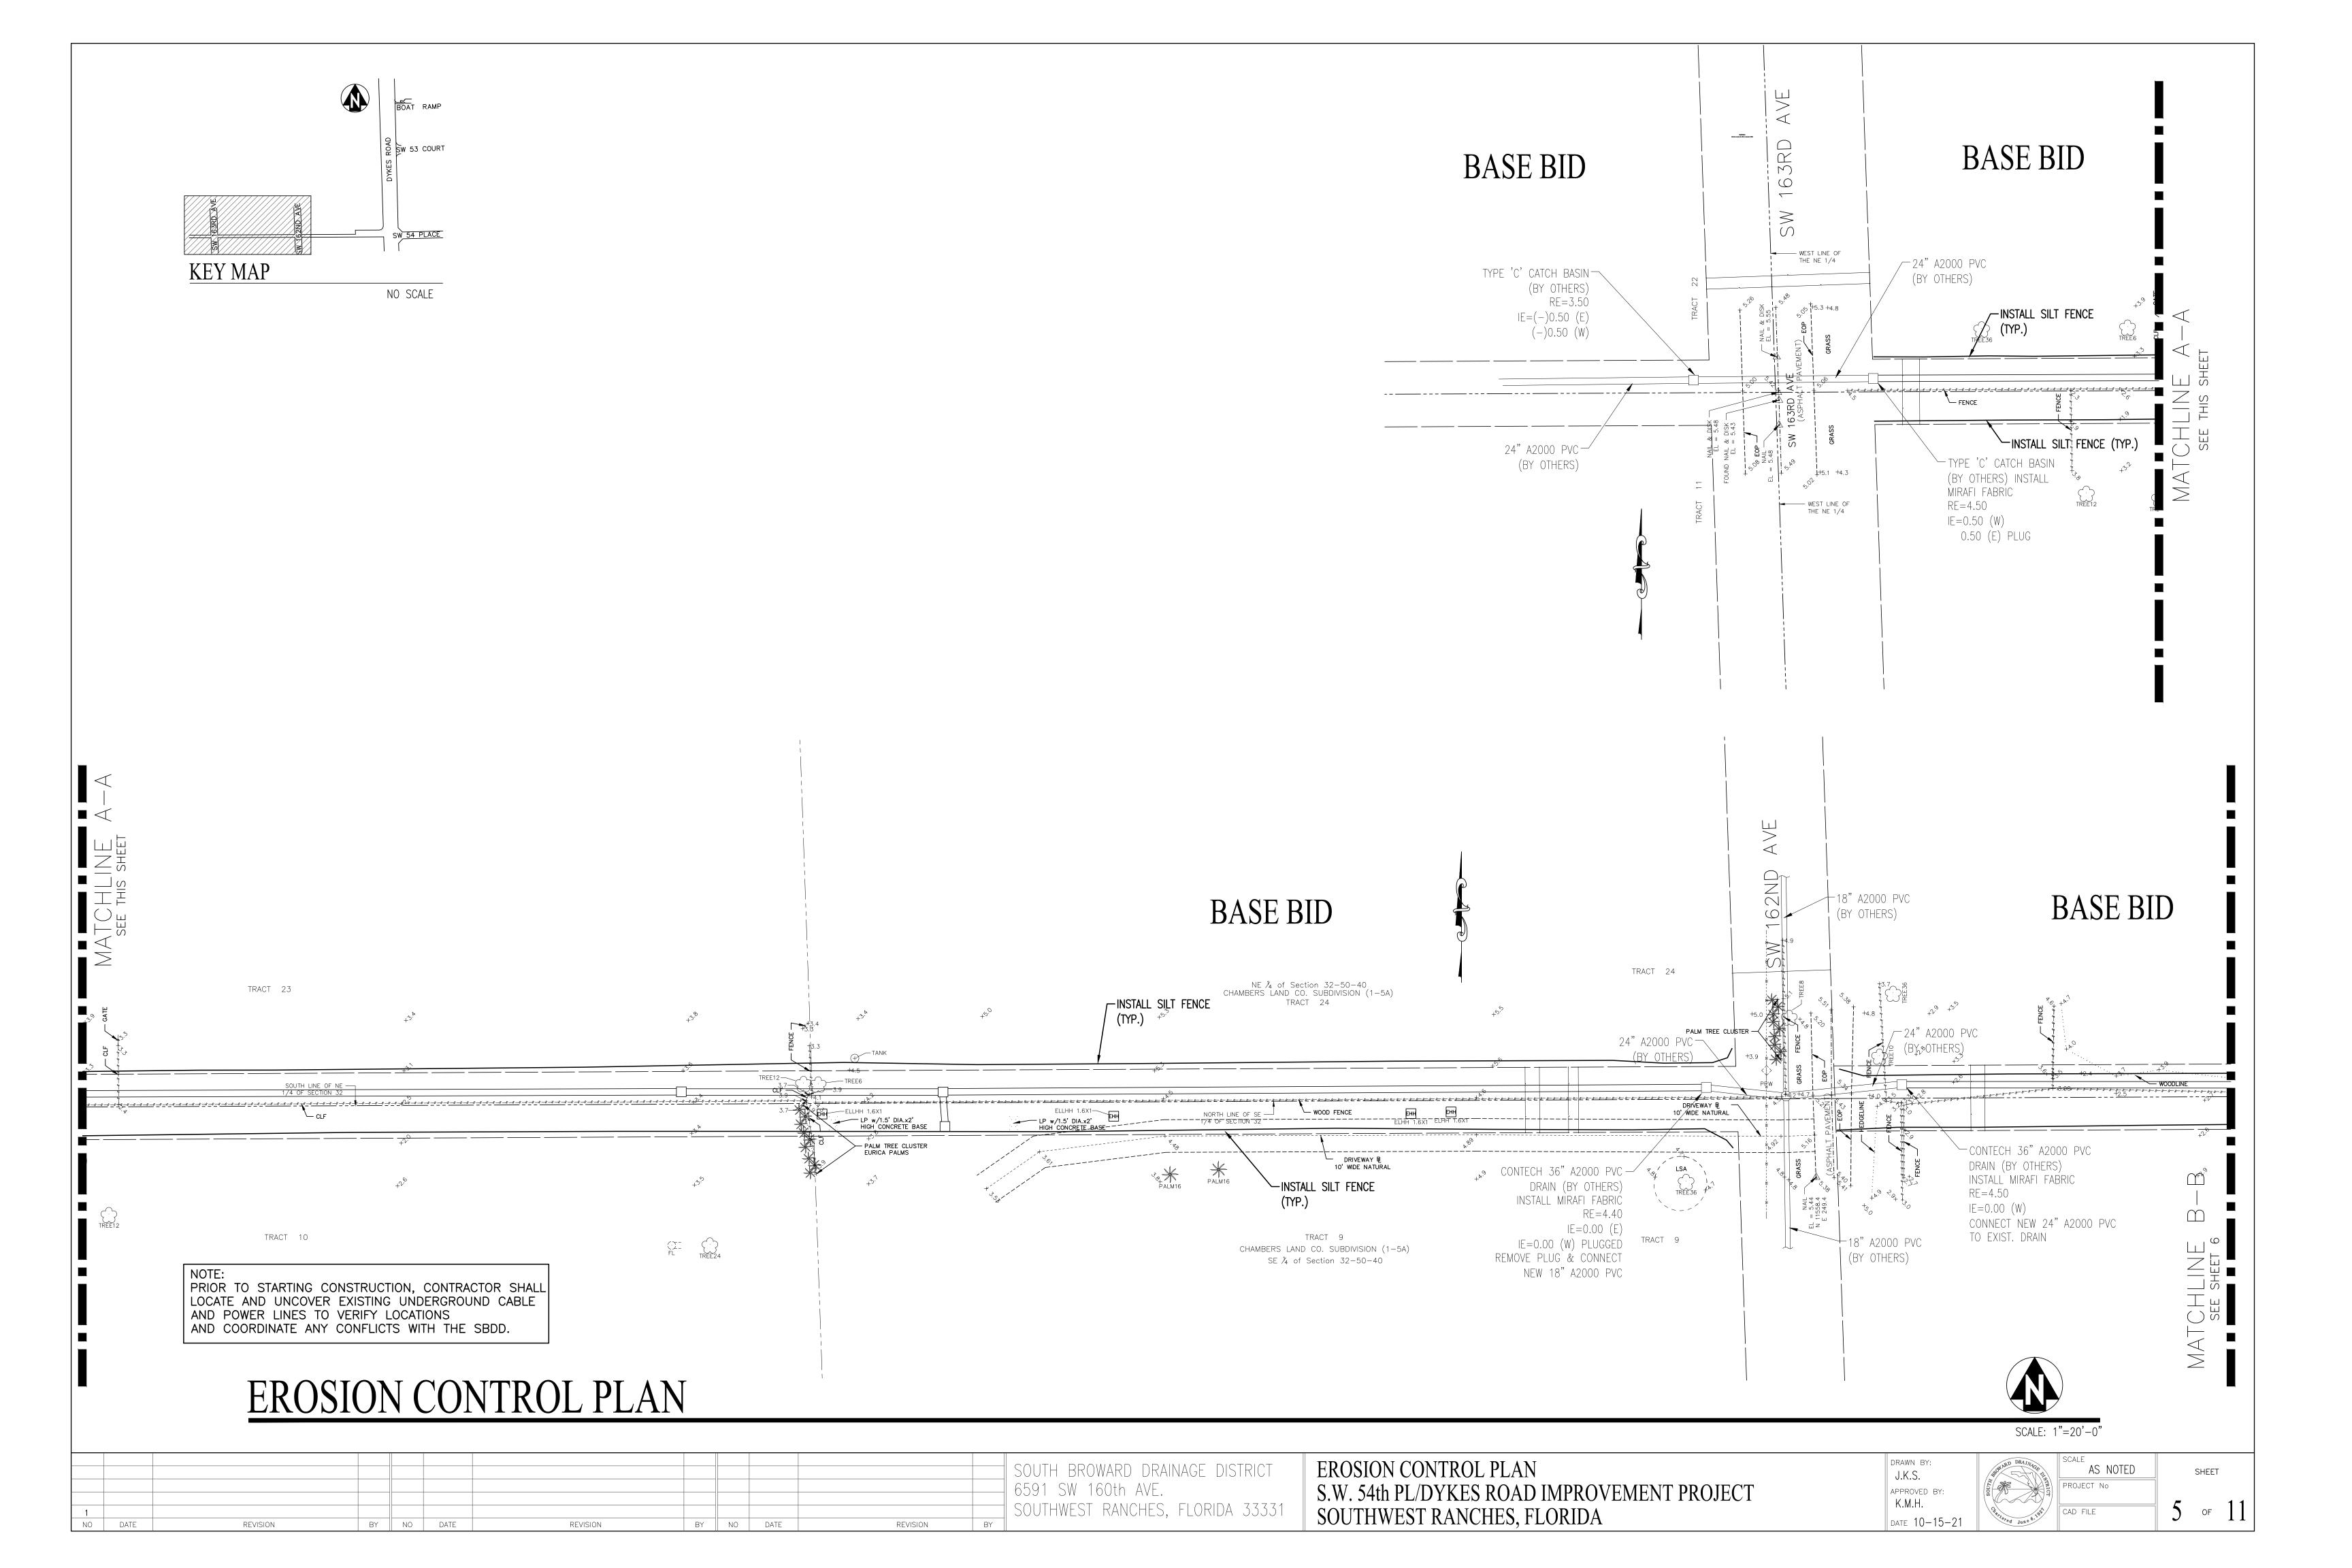

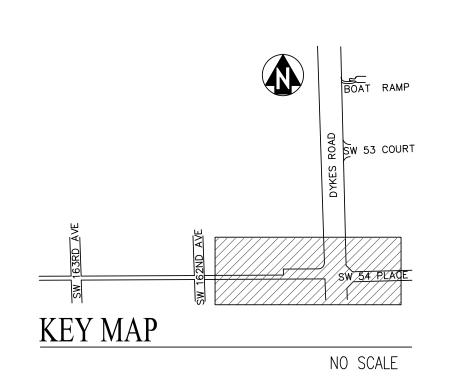

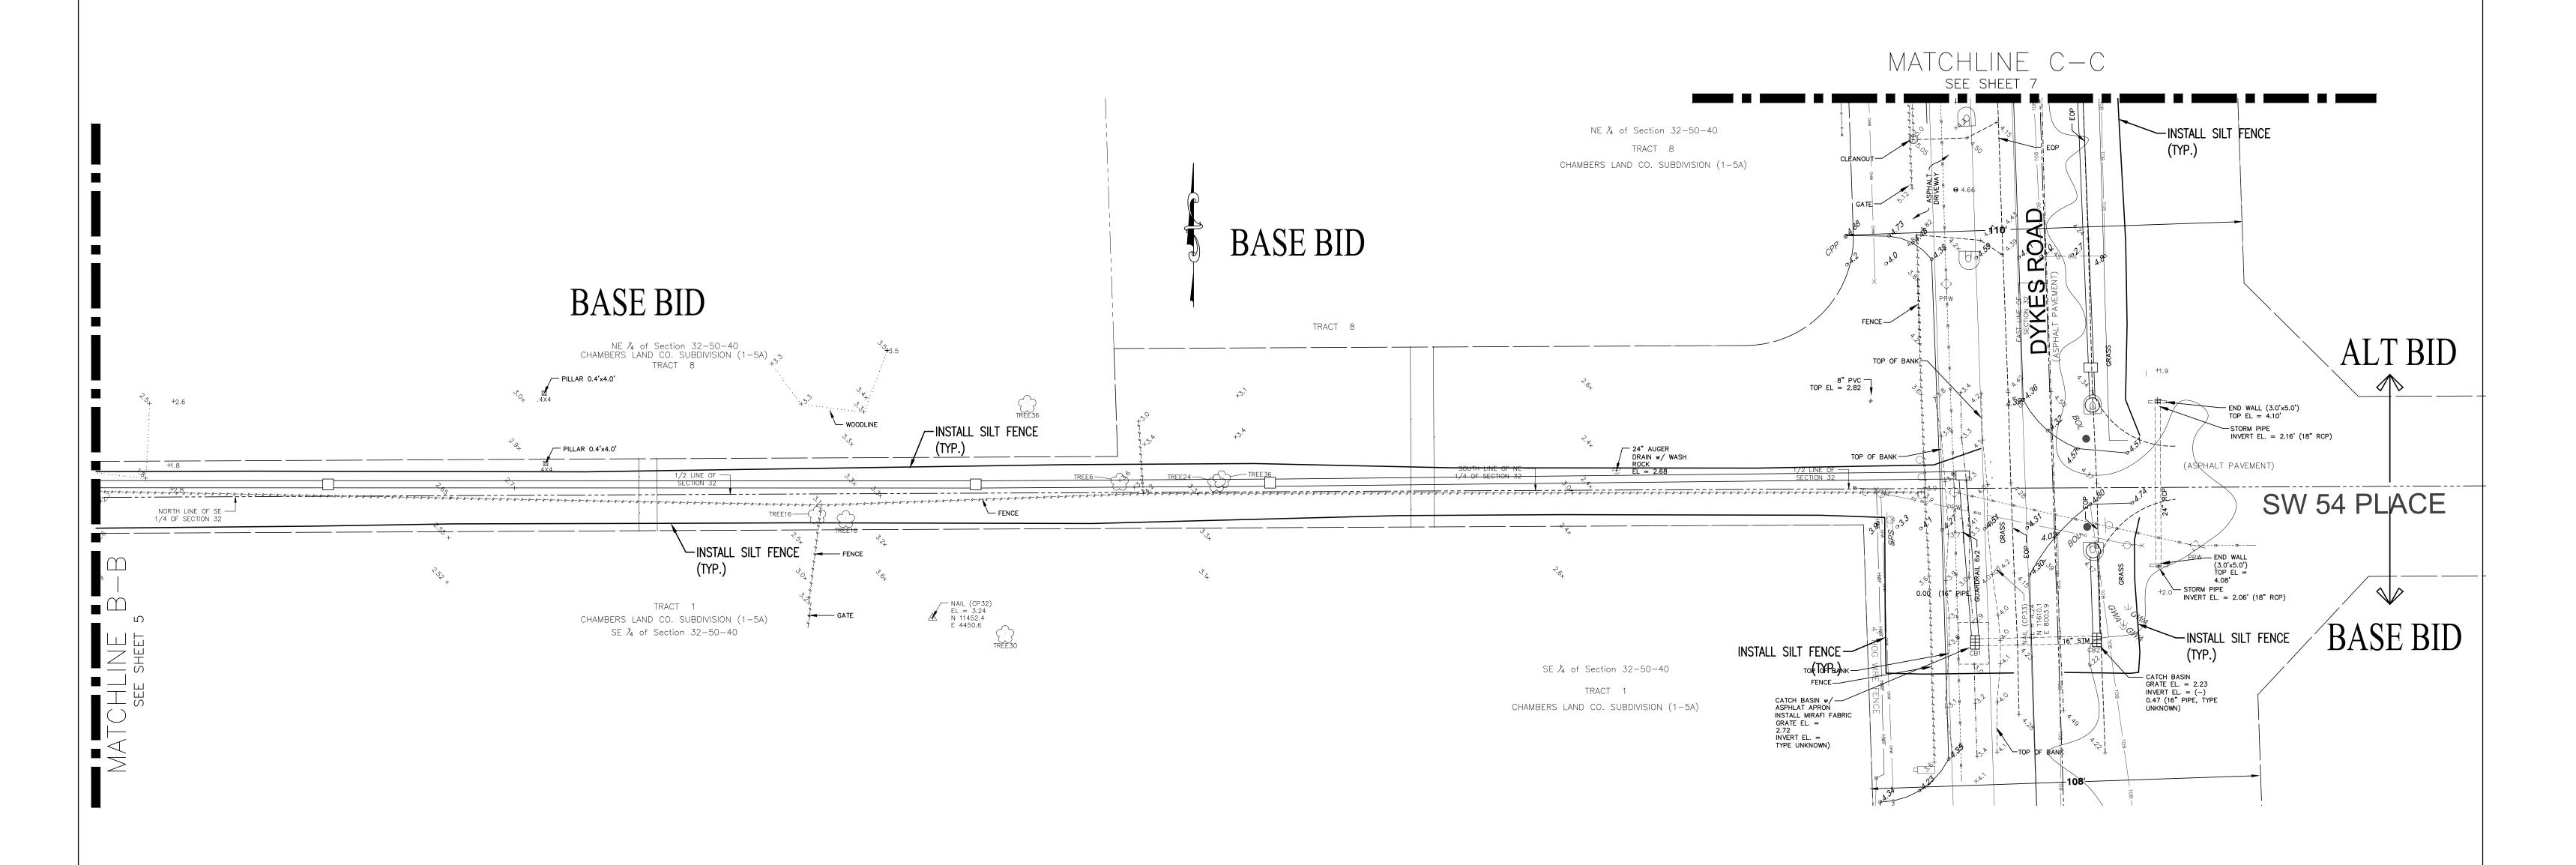


NOTE:
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EROSION CONTROL PLAN



SCALE: 1"=20'-0"

			SOUTH BROWARD DRAINAGE DISTRICT	EROSION CONTROL PLAN	DRAWN BY:	SCALE AS NOTED	SHEET
			6591 SW 160th AVE.	S.W. 54th PL/DYKES ROAD IMPROVEMENT PROJECT	APPROVED BY:	PROJECT No	
1 NO DATE REVISION BY NO	O DATE REVISION BY NO	DATE REVISION BY	SOUTHWEST RANCHES, FLORIDA 33331	SOUTHWEST RANCHES, FLORIDA	DATE 10-15-21	CAD FILE	6 OF 11

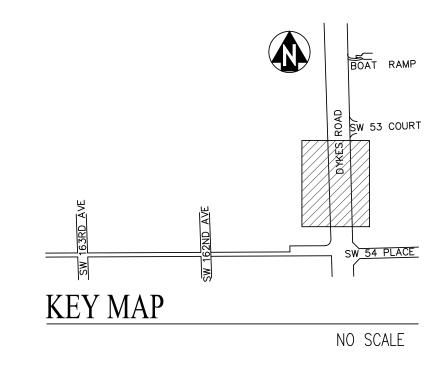

PRIOR TO STARTING CONSTRUCTION, CONTRACTOR SHALL LOCATE AND UNCOVER EXISTING UNDERGROUND CABLE AND POWER LINES TO VERIFY LOCATIONS AND COORDINATE ANY CONFLICTS WITH THE SBDD.

EROSION CONTROL PLAN

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1												
NO	DATE	REVISION	BY	ll no	DATE	REVISION	BY	ll no l	DATE	REVISION E	BY	

SOUTH BROWARD DRAINAGE DISTRICT 6591 SW 160th AVE. SOUTHWEST RANCHES, FLORIDA 33331

SHEET of 11

SCALE: 1"=20'-0" EROSION CONTROL PLAN DRAWN BY: J.K.S. PROJECT No S.W. 54th PL/DYKES ROAD IMPROVEMENT PROJECT APPROVED BY: K.M.H. SOUTHWEST RANCHES, FLORIDA

MATCHLINE C-C see sheet 6

MATCHLINE D-D

SEE SHEET 8

ROAD

RIGHT-OF-WAY

-INSTALL SILT FENCE

CB RIM ELEV. = 1.93 FEET (NAVD88) 18" CMP W INV. ELEV. = (-)0.41 FEET BOTTOM ELEV. = (-)1.84 FEET

-INSTALL SILT FENCE

—INSTALL SILT FENCE

FLA FRUIT LANDS CO SUB NO 1, P.B 2, PAGE 17
SECTION 33, TOWNSHIP 50 SOUTH, RANGE 40 EAST
TRACT 25 LESS EAST 1150 FEET
& LESS RIGHT OF-WAY
FOR SW 160 AVE & FOR SW 54 PLACE

(STRUCTURE IS FULL OF WATER & DEBRIS)

FLA FRUIT LANDS CO SUB NO 1, P.B. 2, PG. 17
SECTION 33, TOWNSHIP 50 SOUTH, RANGE 40 EAST,
TRACT 26, WEST 132 FEET OF EAST 1038 FEET

& TRACT 26 LESS EAST 1170 FEET
& LESS WEST 15 FEET RIGHT-OF-WAY

ALT BID

CHAMBERS LAND CO SUB NE1/4, P.B. 1, PG. 5A SECTION 32, TOWNSHIP 50 SOUTH, RANGE 40 EAST TRACT 7 S1/2 LESS EAST 53 FEET FOR ROAD RIGHT-OF-WAY & LESS WEST 297.62 FEET

APPROXIMATE DRIP LINE

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CHAMBERS LAND CO SUB NE1/4, P.B. 1, PG. 5A
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NE1/4 & EXTERNAL AREA


NE $\frac{7}{4}$ of Section 32-50-40


BOTTOM ELEV. = 2.52 FEET

BM ELEV. = 3.91 FEET (NVGD88)-IRON ROD & CAP LB6860

RIGHT-OF-WAY —

APPROXIMATE DRIP LINE-

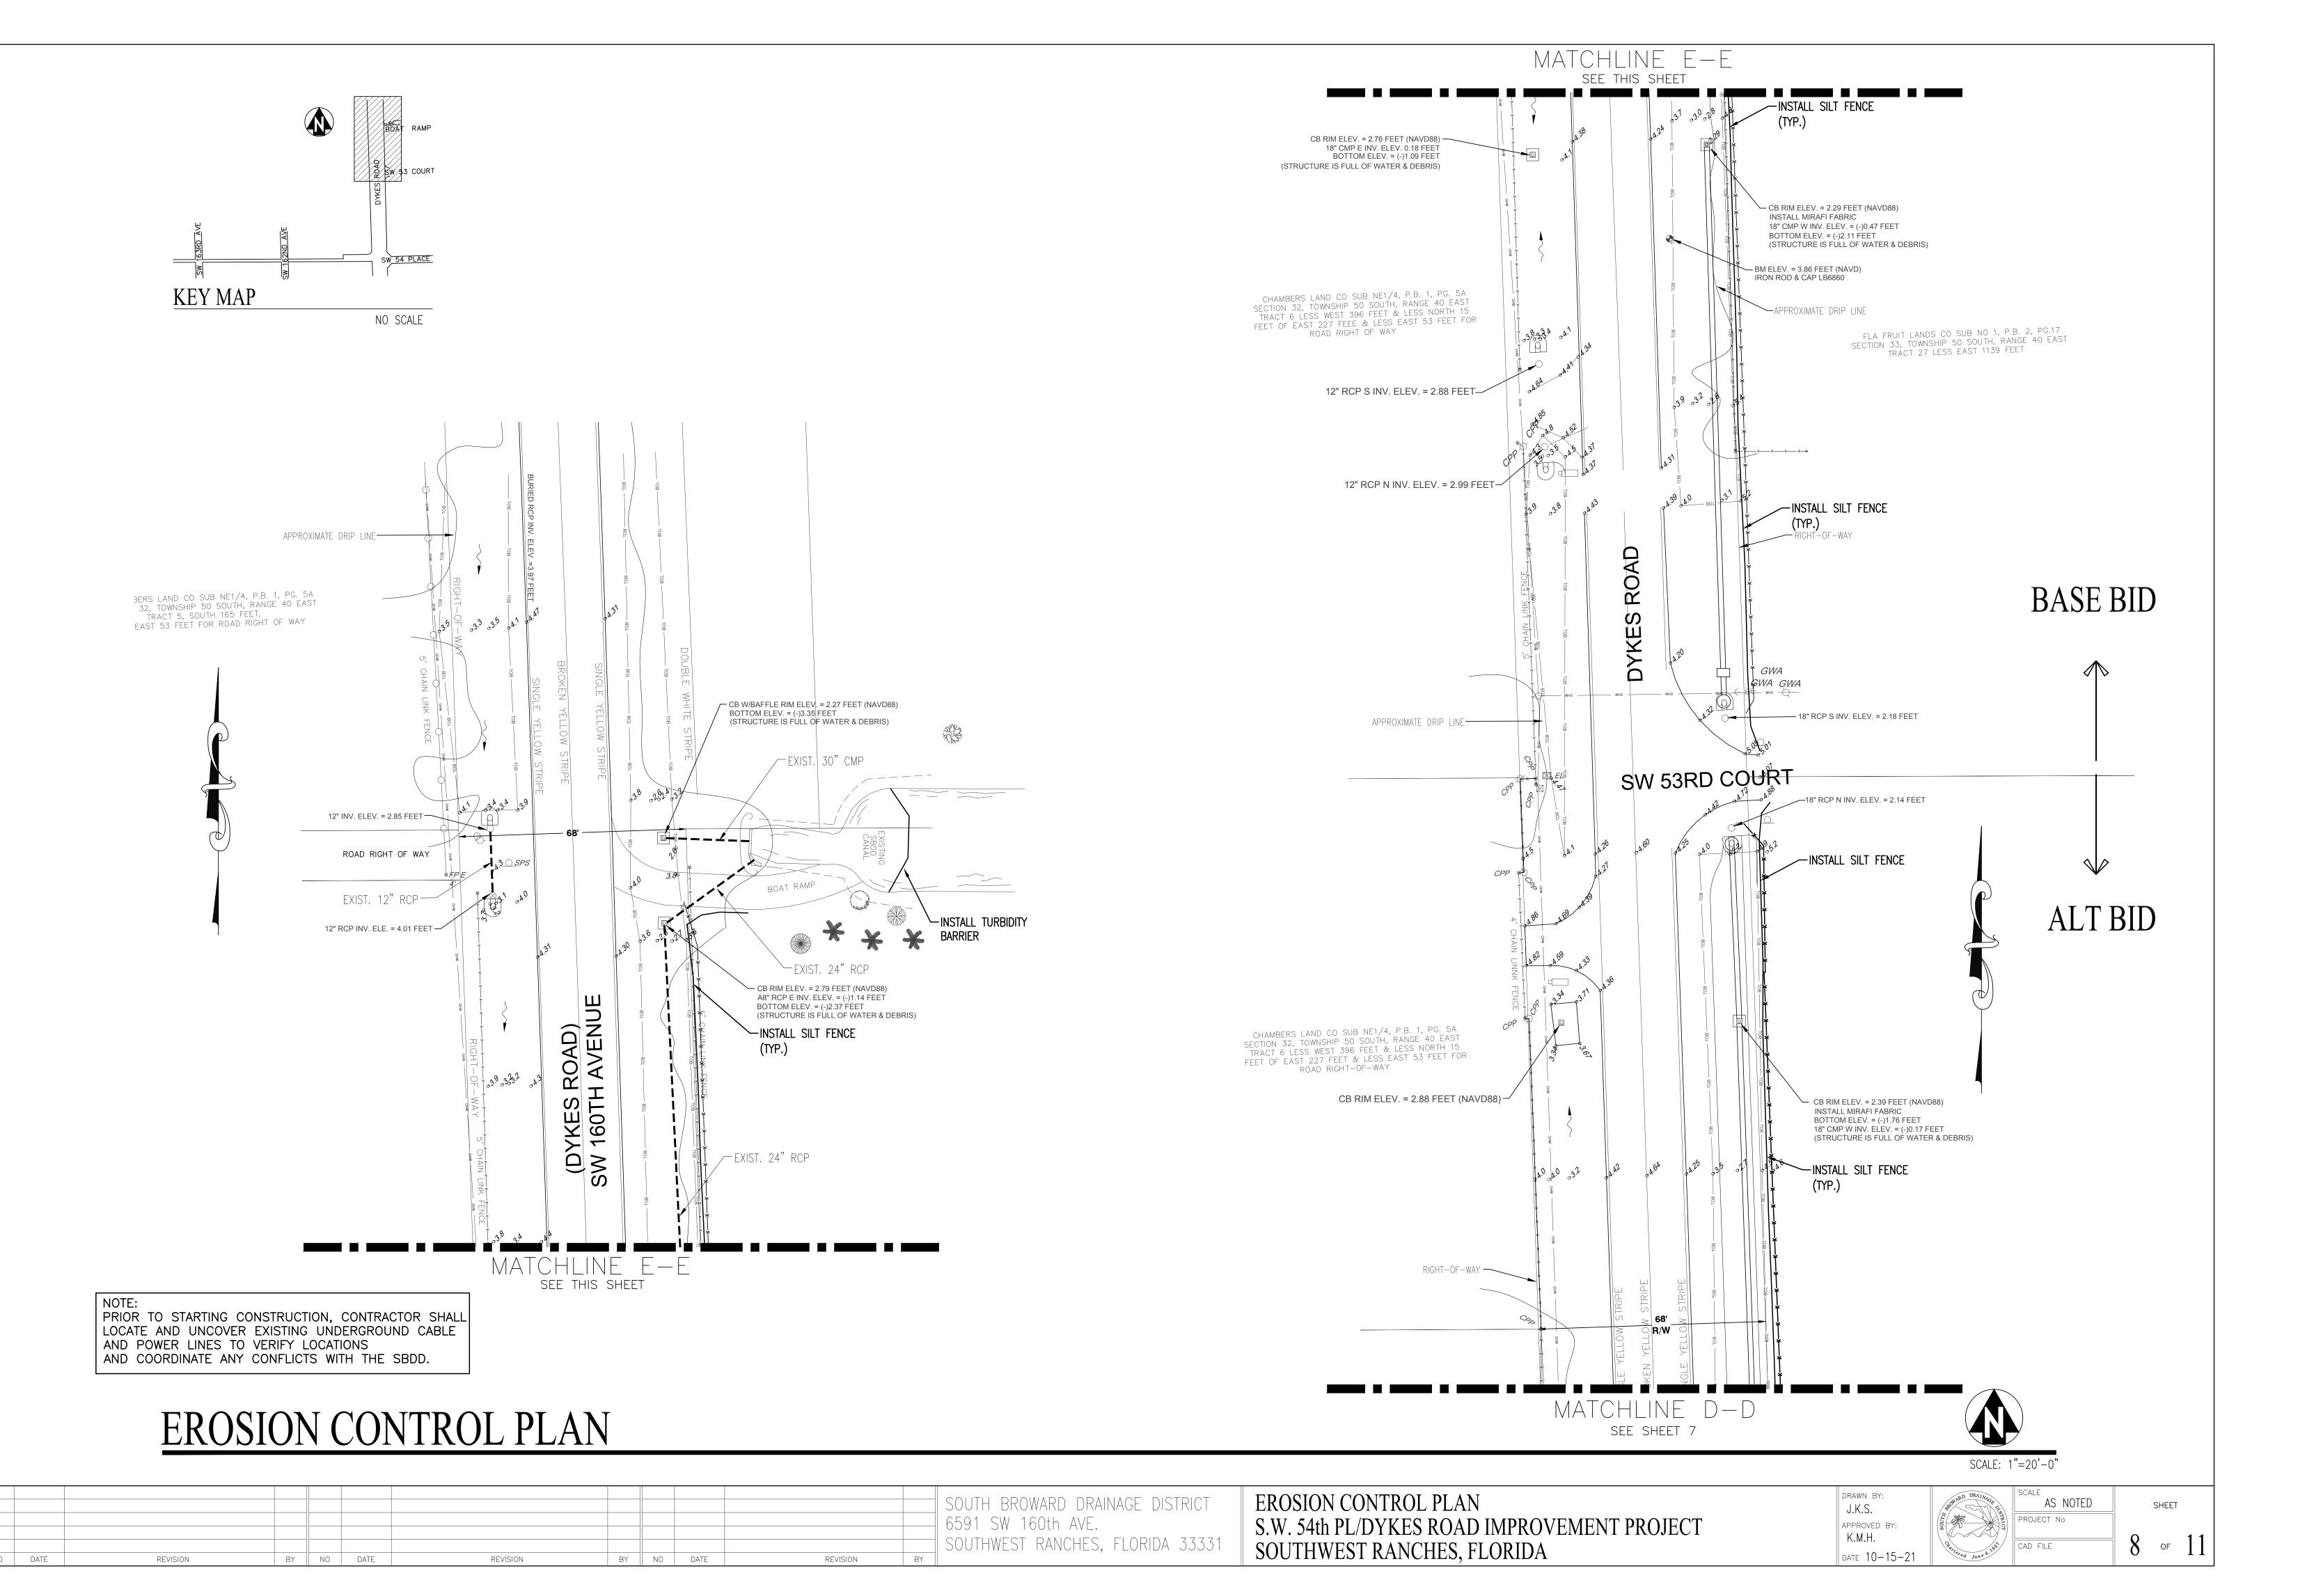


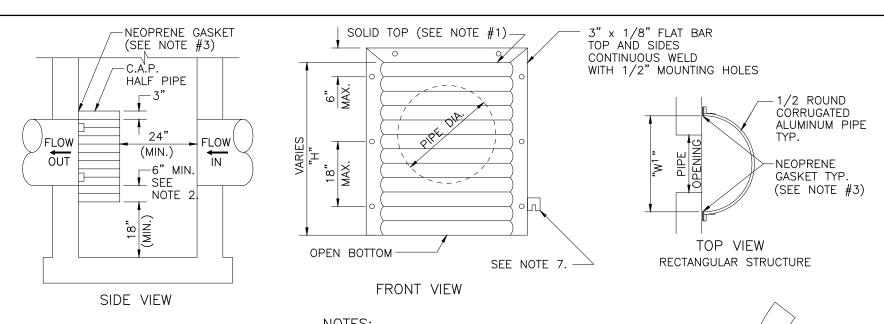


PIPE DIA.	W ¹ (IN)	W ² (IN)	T (GAUGE)	H (IN)
15"	21"	21"	16	VARIES
18"	24"	24"	16	VARIES
21"	30"	30"	16	VARIES
24"	30"	36"	16	VARIES
30"	36"	42"	14	VARIES
36"	42"	48"	14	VARIES
42"	48"	54"	14	VARIES
48"	54"	60"	14	VARIES
54"	60"	66"	14	VARIES

1. RECTANGULAR STRUCTURE

NO DATE

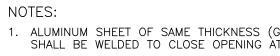

AND TOP OF ALL BAFFLES.

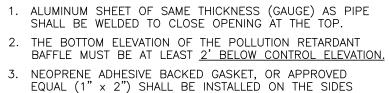


- 4. POLLUTION RETARDANT BAFFLE TO BE FASTENED IN PLACE WITH 3/8"x4" STAINLESS STEEL "RED HEADS", OR APPROVED EQUAL.
- 5. ALL EXFILTRATION TRENCHES SHALL HAVE A POLLUTION RETARDANT BAFFLE AT EACH CONNECTION POINT TO A STRUCTURE (SEE EXFILTRATION TRENCH DETAIL). 6. FIBERGLASS BAFFLES ARE NOT PERMITTED.
- 7. MOUNTING BRACKETS MAY BE ADDED TO FLAT BARS TO EASE INSTALLATION IN ROUND STRUCTURES. SPACING TO MATCH HOLES IN FLAT BARS.


TOP VIEW

ROUND STRUCTURE

POLLUTION RETARDANT BAFFLE DETAIL

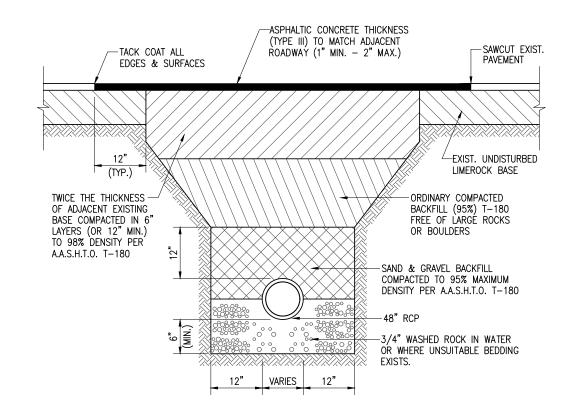

PAVEMENT RESTORATION DETAIL

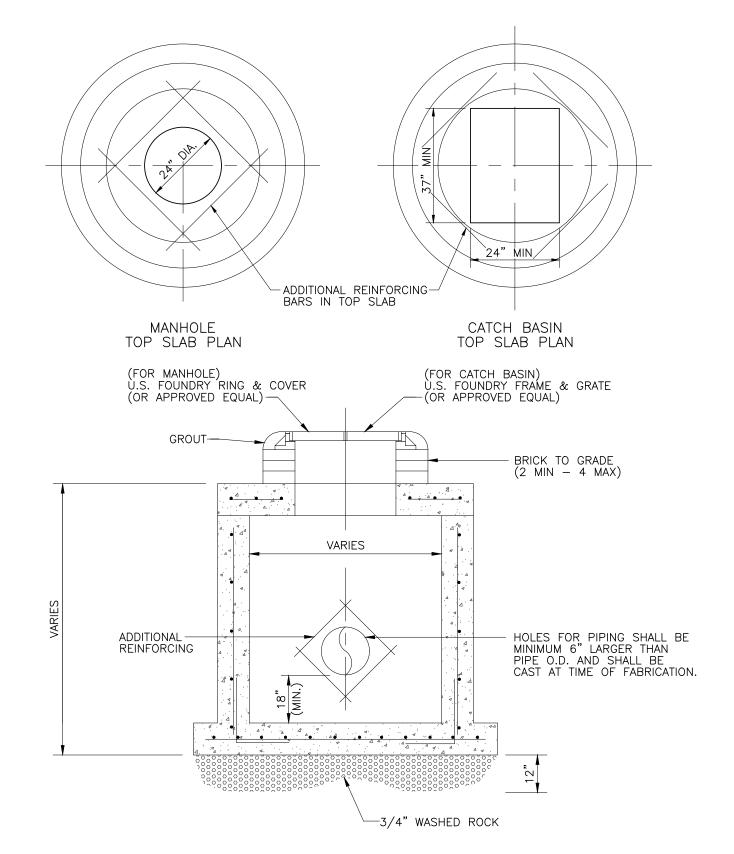


(ALL FDOT TYPE STRUCTURES ARE APPROVED.) PRECAST CATCH BASIN AND MANHOLE DETAIL

BY NO DATE

REVISION


BY NO DATE

REVISION

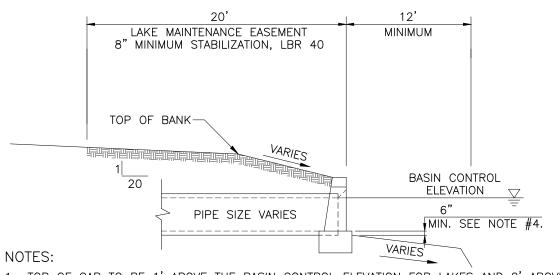

- 1. TOP OF CAP TO BE 1' ABOVE THE BASIN CONTROL ELEVATION FOR LAKES AND 2' ABOVE BASIN CONTROL ELEVATION FOR CANALS, UNLESS OTHERWISE APPROVED BY THE DISTRICT.
- 2. REQUIRED FOR ALL LAKE AND CANAL INTERCONNECTS.
- 3. CONCRETE AND RIP-RAP ENDWALLS ARE ACCEPTED PER FDOT INDEX 250-255 AND INDEX 258 WITH EXCEPTIONS AS NOTED IN SECTION 2.15 OF THE SBDD DESIGN CRITERIA MANUAL.
- 4. CHANNEL IN FRONT OF PIPE TO BE MIN 6" BELOW THE INVERT OF THE PIPE AND AT LEAST 1 1/2 TIMES THE DIA. OF THE PIPE TO THE DEEP CUT LINE AND CENTERED ON THE PIPE.


LAKE OUTFALL DETAIL WITH HEADWALL

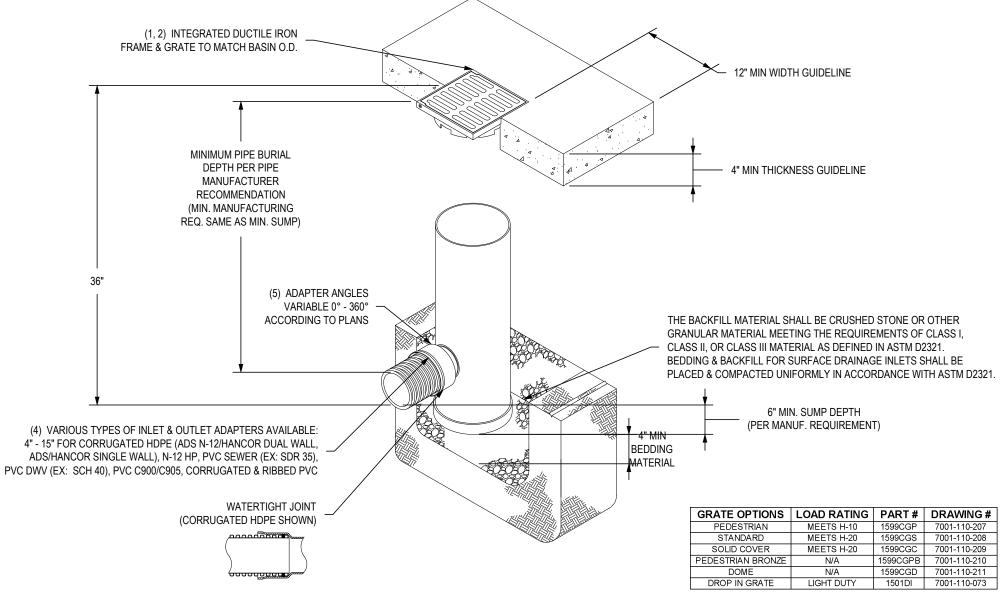

1 - GRATES/SOLID COVER SHALL BE DUCTILE IRON PER ASTM A536 GRADE 70-50-05. WITH THE EXCEPTION OF THE BRONZE GRATE. 2 - FRAMES SHALL BE DUCTILE IRON PER ASTM A536 GRADE 70-50-05

- 3 DRAIN BASIN TO BE CUSTOM MANUFACTURED ACCORDING TO PLAN DETAILS. RISERS ARE NEEDED FOR BASINS OVER 84" DUE TO SHIPPING RESTRICTIONS SEE DRAWING NO. 7001-110-065 4 - DRAINAGE CONNECTION STUB JOINT TIGHTNESS SHALL CONFORM TO ASTM D3212 FOR CORRUGATED HDPE (ADS N-12/HANCOR DUAL WALL),
- 5 ADAPTERS CAN BE MOUNTED ON ANY ANGLE 0° TO 360°. TO DETERMINE MINIMUM ANGLE BETWEEN ADAPTERS SEE DRAWING NO. 7001-110-012.

15" YARD DRAIN DETAIL

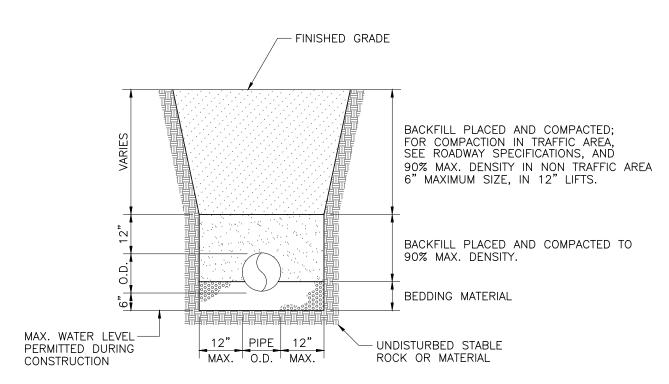

REVISION

- 1. WHERE SOIL CONDITION CANNOT BE MAINTAINED AS SHOWN ABOVE, PROVIDE APPROVED MEANS OF CONSTRUCTION.
- 2. WHERE REQUIRED SHEETING AND SHORING SHALL BE IN ACCORDANCE WITH THE LOCAL GOVERNMENTAL AGENCY.
- 3. MUCK OR OTHER UNSUITABLE MATERIAL SHALL BE COMPLETELY REMOVED.
- 4. WHEN THE PIPE IS LAID IN THE PREPARED TRENCH, TRUE TO LINE AND GRADE, THE PIPE BARREL SHALL RECEIVE CONTINUOUS UNIFORM SUPPORT. WHERE NECESSARY, COURSE SAND, PEA ROCK OR 3/4" LIMESTONE GRAVÉL SHALL BE USED TO PROVIDE UNIFORM BEDDING.

5. JOINTS MAY BE REQUIRED TO BE WRAPPED AT THE

DISCRETION OF THE DISTRICT AND THE SITE CONDITIONS.

- BACKFILL MATERIAL SHALL BE NON-COHESIVE AND NON-PLASTIC SOIL THAT IS FREE OF ALL DEBRIS, LUMPS, WOOD BROKEN PAVING OR ANY ORGANIC OR UNSUITABLE MATERIAL BACKFILL MATERIAL PLACED WITHIN 12" OF THE PIPE SHALL CONTAIN NO ROCKS OR STONES LARGER THAN 3-1/2" INCHES IN DIAMETER. NO ROCKS OR STONES LARGER THAN 6" IN DIAMETER WILL BE PERMITTED IN THE REMAINING BACKFILL UNLESS OTHERWISE SPECIFIED.
- 90 PERCENT OF THE MAXIMUM DRY DENSITY DETERMINED BY AASHTO T-180. BACKFILL AND COMPACTION SHALL BE IN ACCORDANCE TO THE STANDARD ENGINEERING DESIGN REQUIRED BY THE LOCAL GOVERNMENTAL AGENCY.

TRENCH BACKFILL SHALL BE COMPACTED TO NOT LESS THAN

TRENCH ECAVATION DETAIL

SOUTH BROWARD DRAINAGE DISTRICT 6591 SW 160th AVE. SOUTHWEST RANCHES, FLORIDA 33331 PAVING AND DRAINAGE DETAILS S.W. 54th PL/DYKES RD IMPROVEMENT PROJECT SOUTHWEST RANCHES, FLORIDA

GENERAL NOTES

- 1 THE FOLLOWING GENERAL NOTES ARE REQUIRED BY THE SOUTH BROWARD DRAINAGE DISTRICT (SBDD). THEY ARE NOT MEANT TO BE ALL INCLUSIVE. IT IS THE ENGINEER'S RESPONSIBILITY TO ADD ANY NOTES WHICH WILL INFORM THE OWNER AND THE CONTRACTOR OF ANY ADDITIONAL REQUIREMENTS OF SBDD.
- 2 THE CONTRACTOR SHALL CONTACT SBDD 48 HOURS OR TWO (2) WORKING DAYS PRIOR TO ANY REQUIRED INSPECTION. TO SCHEDULE INSPECTIÓNS, PLEASE CALL SBDD AT (954)680-3337. SBDD'S WORKING HOURS ARE FROM 8:00 AM TO 4:30 PM. MONDAY THROUGH FRIDAY EXCEPT HOLIDAYS.
- 3 ANY REVISIONS TO PLANS PERMITTED BY SBDD MUST BE APPROVED BY SBDD PRIOR TO
- 4 A PRECONSTRUCTION MEETING SHALL BE SCHEDULED AND HELD AT LEAST FIVE (5) DAYS PRIOR TO BEGINNING CONSTRUCTION.
- 5 A SET OF SHOP DRAWINGS SHALL BE SUBMITTED TO SBDD AFTER APPROVAL BY THE
- 6 DURING CONSTRUCTION, SBDD PERSONNEL WILL INSPECT THE FOLLOWING: INSTALLATION OF ALL UNDERGROUND DRAINAGE FACILITIES BEFORE BACKFILLING, BACKFILLING OF DRAINAGE TRENCHES. SHAPING OF CANAL AND LAKE BANKS FROM THE DEEP CUT TO THE UPLAND EASEMENT LINE OR AS REQUIRED BY SBDD. AND ANY OTHER DRAINAGE RELATED CONSTRUCTION WORK. RE-INSPECTIONS OR EXTRAORDINARY INSPECTIONS WILL BE SUBJECT TO ADDITIONAL FEE
- 7 THE CONTRACTOR CONSTRUCTING OR EXCAVATING LAKES OR OTHER WATER BODIES SHALL EXCERCISE EXTREME CAUTION TO ENSURE THAT THE SIDE SLOPES AND DEEP CUT LINES ARE CONSTRUCTD IN ACCORDANCE WITH THE APPROVED PLANS FOR THE DEVELOPMENT. THE CONTRACTOR OR OWNER SHALL PERIODICALLY, OR AS REQUIRED BY SBDD, OBTAIN A SURVEY, FROM A FLORIDA REGISTERED SURVEYOR OF THE LOCATION OF THE DEEP CUT LINES PRIOR TO FORMING THE SIDE SLOPES. THIS SURVEY SHALL BE PERFORMED PRIOR TO THE OWNER/CONTRACTOR BEGINNING CONSTRUCTION OF ANY BUILDING PADS ADJACENT TO THE WATER BODY. IN THE EVENT THAT THE CONTRACTOR OVER DIGS THE WATER BODY, THE OWNER/CONTRACTOR SHALL SUBMIT TO SBDD ITS SOLUTION TO CORRECT THE OVER DIGGING. ANY SUGGESTED REMEDY OR CORRECTION MUST BE APPROVED BY SBDD BEFORE THE CONTRACTOR BEGINS THE PROPOSED CORRECTION/REMEDY.
- 8 PAVING AND DRAINAGE "AS-BUILT" PLANS CERTIFIED BY THE ENGINEER OF RECORD AND APPROVED BY SBDD'S ENGINEER AND DIRECTOR WILL BE REQUIRED BEFORE THE RELEASE OF THE BOND OR LETTER OF CREDIT. AS-BUILTS SHALL BE PROVIDED AS AN OVERLAY OF THE APPROVED CONSTRUCTION DRAWINGS AND AT THE SAME SCALE AS ORIGINALLY SUBMITTED. AS-BUILT SUBMITTALS SHALL CONFORM TO THE REQUIREMENTS OF SECTION SIX (6) OF SBDD'S CRITERIA MANUAL. AS-BUILTS MUST ALSO BE PROVIDED ON AN AUTOCAD DISC.
- 9 AS-BUILT DRAWINGS OF WATER BODIES SHALL INCLUDE THE DATA ADDRESSED IN THE "AS-BUILT LAKE SECTION" IN EXHIBIT 26 OF SBDD'S CRITERIA MANUAL. THE AS-BUILT CROSS SECTIONS SHALL BE PROVIDED AT NOT MORE THAN 100 FOOT INTERVALS AND AT ALL OUTFALL PIPES CONSTRUCTED WITHOUT HEADWALLS.
- 10 SBDD WILL NOT COMPLETE THE FINAL INSPECTION UNTIL THE AS-BUILT PACKAGE WHICH MUST INCLUDE THE ENGINEER'S CERTIFICATION AND TEST RESULTS FOR STABILIZATION OF LAKE/CANAL MAINTENANCE EASEMENTS, ARE RECEIVED.


DATE 10-15-21

DRAWN BY:

J.K.S.

APPROVED BY: K.M.H.




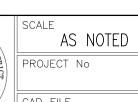

SHEET






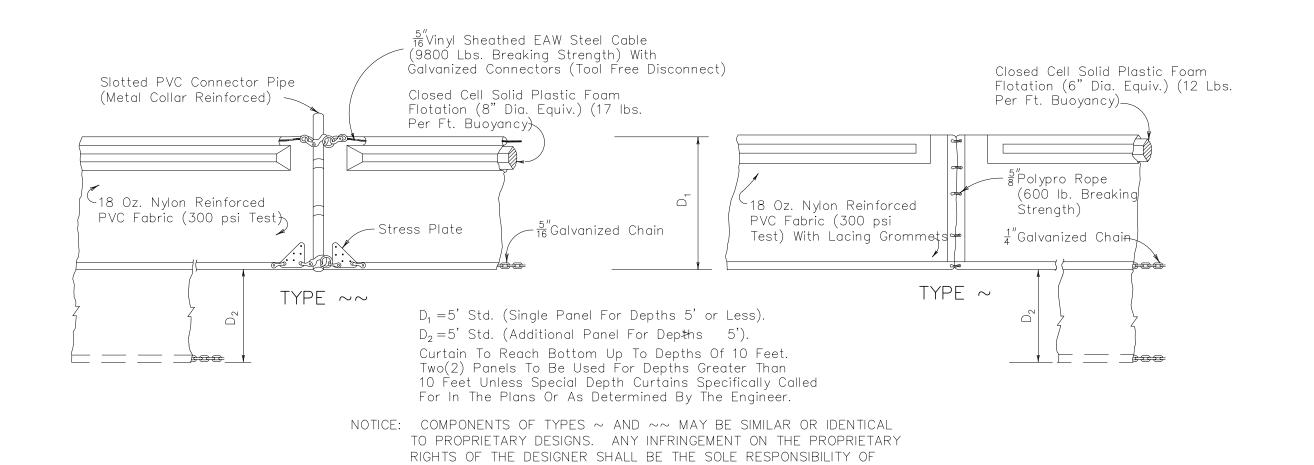

FLOATING TURBIDITY BARRIERS

THE USER. SUBSTITUTIONS FOR TYPES ~ AND ~~ SHALL BE AS

APPROVED BY THE ENGINEER.

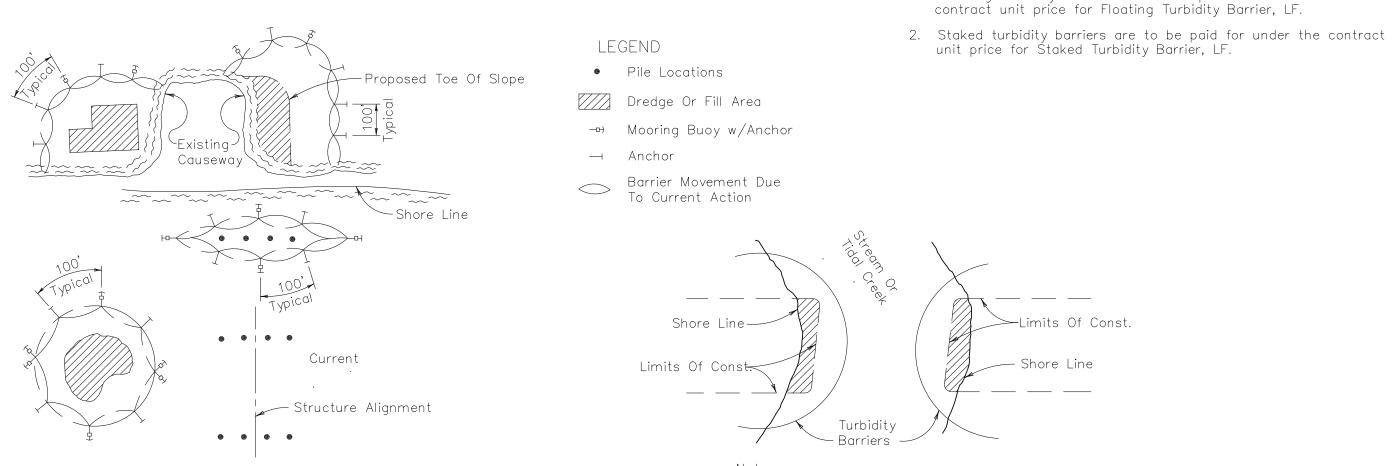


NOTES:

- 1. Turbidity barriers are to be used in all permanent bodies of water regardless of water depth.
- 2. Number and spacing of anchors dependent on current velocities.
- 3. Deployment of barrier around pile locations may vary to accommodate construction operations.
- 4. Navigation may require segmenting barrier during construction operations.
- 5. For additional information see Section 104 of the Standard Specifications.

Note: Turbidity barriers for flowing streams and tidal creeks may be either floating, or staked types or any combinations of types that will suit site conditions and meet erosion control and water quality requirements. The barrier type(s) will be at the Contractors option unless otherwise specified in the plans, however payment will be under the pay item(s) established in the plans for Floating Turbidity Barrier and/or Staked Turbidity Barrier. Posts in staked turbidity barriers to be installed in vertical


position unless otherwise directed by the

TURBIDITY BARRIER APPLICATIONS

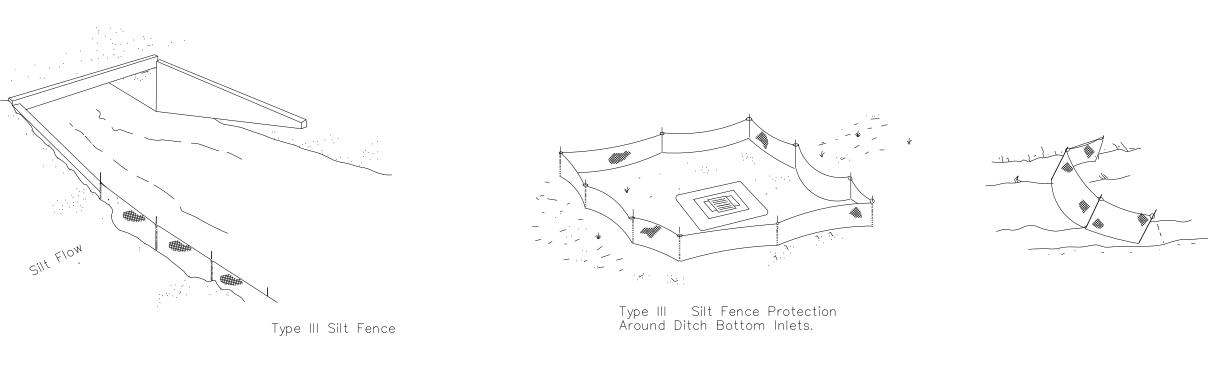

Do not deploy in a manner that silt fences will act as a dam across permanent flowing watercourses. Silt fences are to be used at upland locations and turbidity barriers used at permanent bodies of water.

SILT FENCE APPLICATIONS

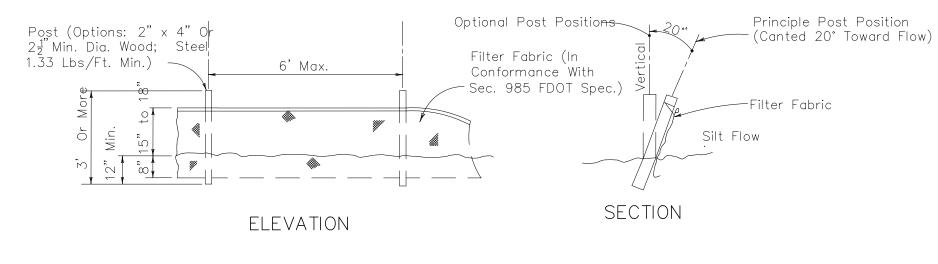

Note: Silt Fence to be paid for under the contract unit price for Staked Silt Fence (LF).

TYPE III SILT FENCE

Silt Flow

Post (Options: 2" x 4" Or $2^{\frac{1}{2}}$ " Min. Dia. Wood; Steel

- 18 Oz. Nylon Reinforced

PVC Fabric (300 psi Test)


1.33 Lbs/Ft. Min.)


6' Max.

STAKED TURBIDITY BARRIER

GENERAL NOTES

1. Floating turbidity barriers are to be paid for under the

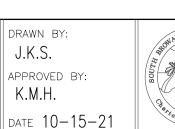

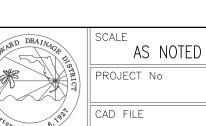

SHEET